

GREEN SPACE (PERVIOUS)

LIGHT POLE, TYPICAL, 29 TOTAL. SEE ELECTRICAL PLANS

PARKING STALL COUNT

ACCESSIBLE ROUTES THROUGHOUT DEVELOPMENT (NOT INCLUDING SIDEWALKS LEADING TO DOORWAYS WHICH ARE ALL ACCESSIBLE)

ACCESSIBLE ANSI TYPE A UNIT

PROPOSED USE

2 MULTIFAMILY RESIDENTIAL LOTS 2 PRIVATE OUTLOTS

1 PUBLIC STREET

1 DEDICATED STREET RIGHT OF WAY

SEE LEGAL DESCRIPTION ON ACCOMPANYING

PROPERTY LOCATION

NOT TO SCALE

PARKING SUMMARY

LOT 1, BLOCK 1: 20 UNIT BLDG SUMMARY (4 X 20 UNIT BLDG) 2- STUDIO UNITS (8) 8 -1 BDRM UNITS (32)

8 -2 BDRM UNITS (32)

2 - 3-BDRM UNITS (8)

REQUIRED PARKING

1 STALL PER STUDIO UNIT (8) 1 STALL PER 1 BDRM UNIT (32) 1.5 STALLS PER 2-BDRM UNIT (48) 2 STALLS PER 3-BDRM UNIT (16) 0.2 SPACES PER UNIT SPILLOVER (16)

TOTAL REQ'D PARKING: 120 STALLS

PROVIDED PARKING:

GARAGE STALLS: 76 (ATTACHED AND DETACHED) SURFACE 9' x 17' PARKING STALLS: 72 VAN ACCESSIBLE HANDICAP PARKING STALLS: 6

TOTAL PROVIDED PARKING: 154 STALLS

LOT 1, BLOCK 2:

20 UNIT BLDG SUMMARY 16 UNIT BLDG SUMMARY (5 X 20 UNIT BLDG) (3 X 16 UNIT BLDG) 2- STUDIO UNITS (10) 2 -STUDIO UNITS (6)

8 -1 BDRM UNITS (40) 4 -1 BDRM UNITS (12) 8 -2 BDRM UNITS (40) 8 -2 BDRM UNITS (24) 2 -3-BDRM UNITS (6) 2 -3-BDRM UNITS (10)

REQUIRED PARKING

16 x 1 STALL PER STUDIO UNIT (16) 51 STALL PER 1 BDRM UNIT (52) 1.5 STALLS PER 2-BDRM UNIT (96) 2 STALLS PER 3-BDRM UNIT (32) 0.2 SPACES PER UNIT SPILLOVER (30)

TOTAL REQ'D PARKING: 226 STALLS

PROVIDED PARKING:

GARAGE STALLS: 114 (ATTACHED AND DETACHED) SURFACE 9' x 17' PARKING STALLS: 138 VAN ACCESSIBLE HANDICAP PARKING STALLS: 11

TOTAL PROVIDED PARKING: 263 STALLS

SITE CAPACITY CALCULATIONS

ZONING: R-3 MULTI-FAMILY RESIDENTIAL 2 STORY BUILDINGS

TOTAL PLATTED LAND AREA: 1,469,714 SF (33.74 Ac) 28th STREET ROW: -75,379 SF (1.7 Ac) 30th STREET ROW: -69,290 SF (1,6 Ac) ADJUSTED TOTAL DEVELOPABLE LAND AREA:

1.325.045 SF (30.45Ac)

RESOURCE PROTECTION AREA:

-9.463 SF FLOODWAY: FLOOD FRINGE: -593,261 SF NET BUILDABLE AREA: 722.321 SF (16.58 Ac)

FLOOR AREA RATIO:

FAR PERMITTED: .61 = 440.616 FAR PROPOSED: .33 = 236,160

DENSITY CALCULATION:

PERMITED: 402 UNITS (16.58 X 24.23) PROPOSED: 228 UNITS

BUILDING SUMMARIES

9-20-UNIT BUILDING FIRST FLOOR: 8,700 SF* SECOND FLOOR: 11,900 SF TOTAL FLOOR AREA

5 x 20,600 = 103,000 SF*

3-16-UNIT BUILDING

FIRST FLOOR: 6,700 SF SECOND FLOOR: 10,220 SE TOTAL FLOOR AREA

3 x 16.920 = 50.760 SF

*AREA DOES NOT INCLUDE GARAGE SPACE

35' SPACING ADJACENT BOTH SIDES OF THE SHEET LS100 LANDSCAPE PLAN.

SETBACKS:

FRONT YARD* REAR YARD SIDE YARD SIDE STREET SIDE YARD 12.5

REQUIRED

BUILDING HEIGHT: 132.1'

LANDSCAPE AREA

REQUIRED: 530,018 SF (12.2 Ac) =40% PROPOSED: 614.584.4 SF (14.1 Ac) =46%

RECREATION SPACE: REQUIRED: 28,339 SF (.65 Ac) =12% PROPOSED:49,429 SF (1.1 Ac) =15%

RECREATION SPACE INCLUDES PET PARKS, RECREATION SPACE AS NOTED, CLUBHOUSE, POOL DECK AND POOL AREA, AND PATIOS/DECKS.

TYPE C BUFFERYARDS ARE REQUIRED ADJACENT THE EASTERN PROPERTY LINE. PLANTING QUANTITIES AND SPECIES SHOWN ON LS100 LANDSCAPE PLAN.

NOTE: PLANT MATERIAL IS NOT ALLOWED ADJACENT THE EXISTING PONDED AREAS DUE TO PLANT VIABILITY AND STORM AND FLOOD POND MAINTENANCE REQUIREMENTS.

BOULEVARD TREES


BOULEVARD TREES ARE REQUIRED WITH 28TH STREET SE. SPECIES ARE SHOWN ON


SHEET SDP





Plan

Development

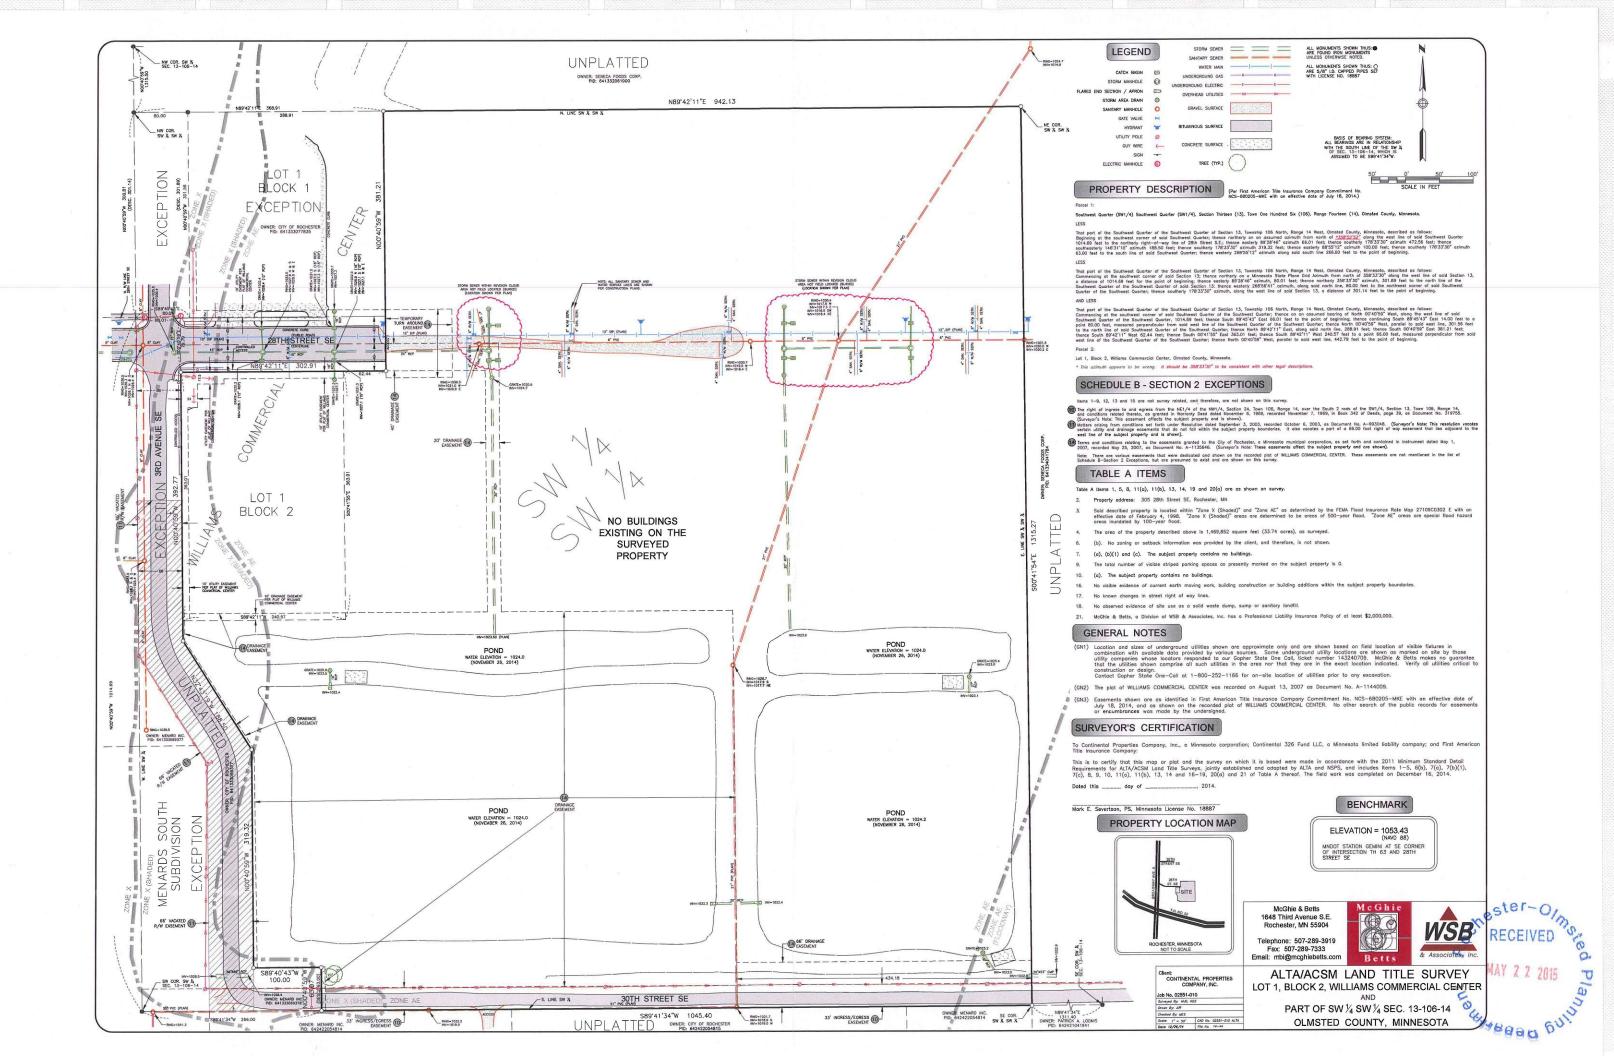

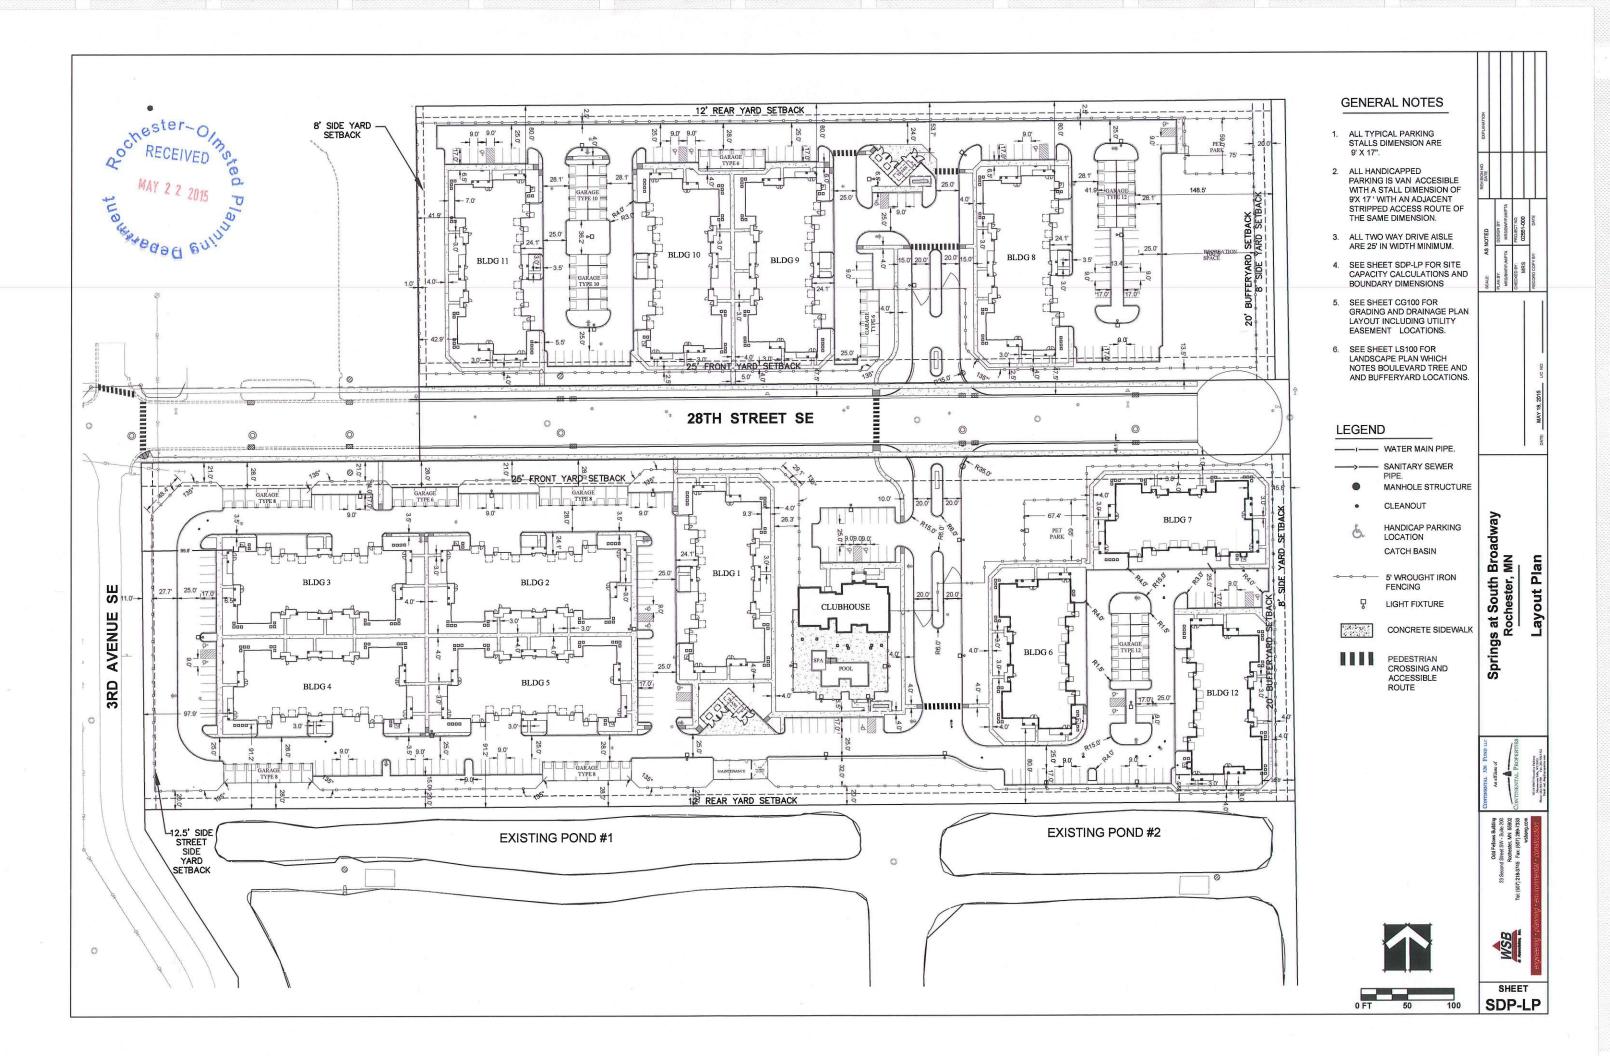

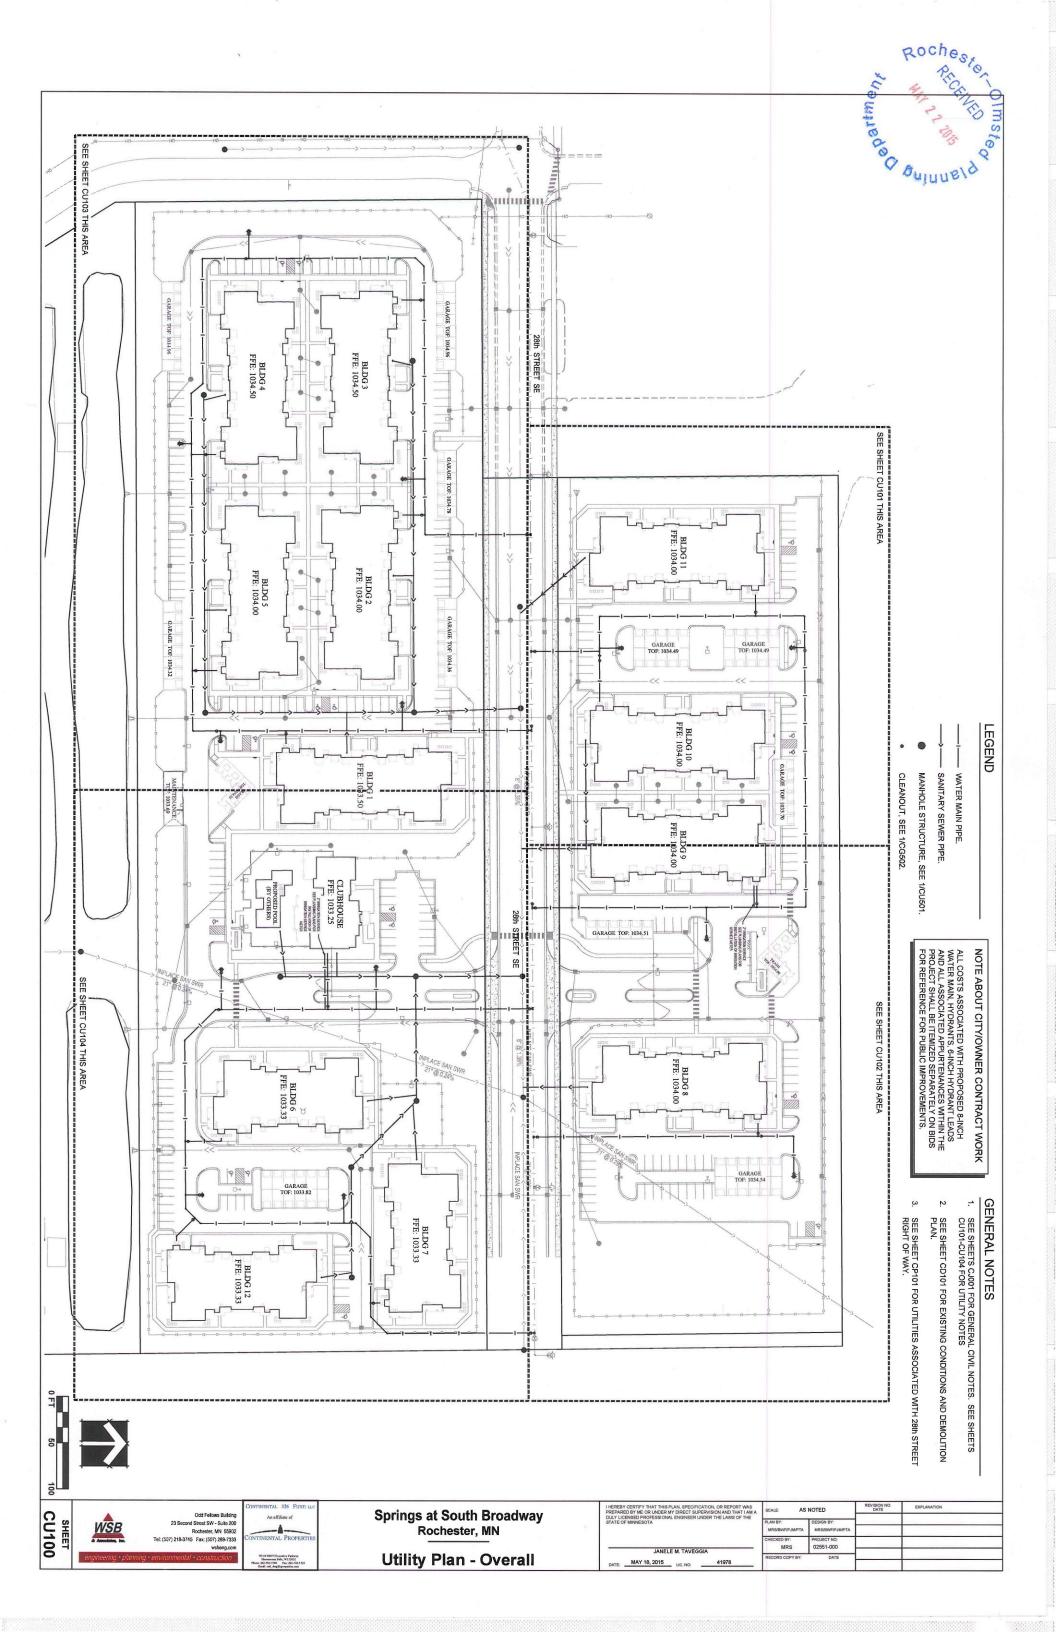

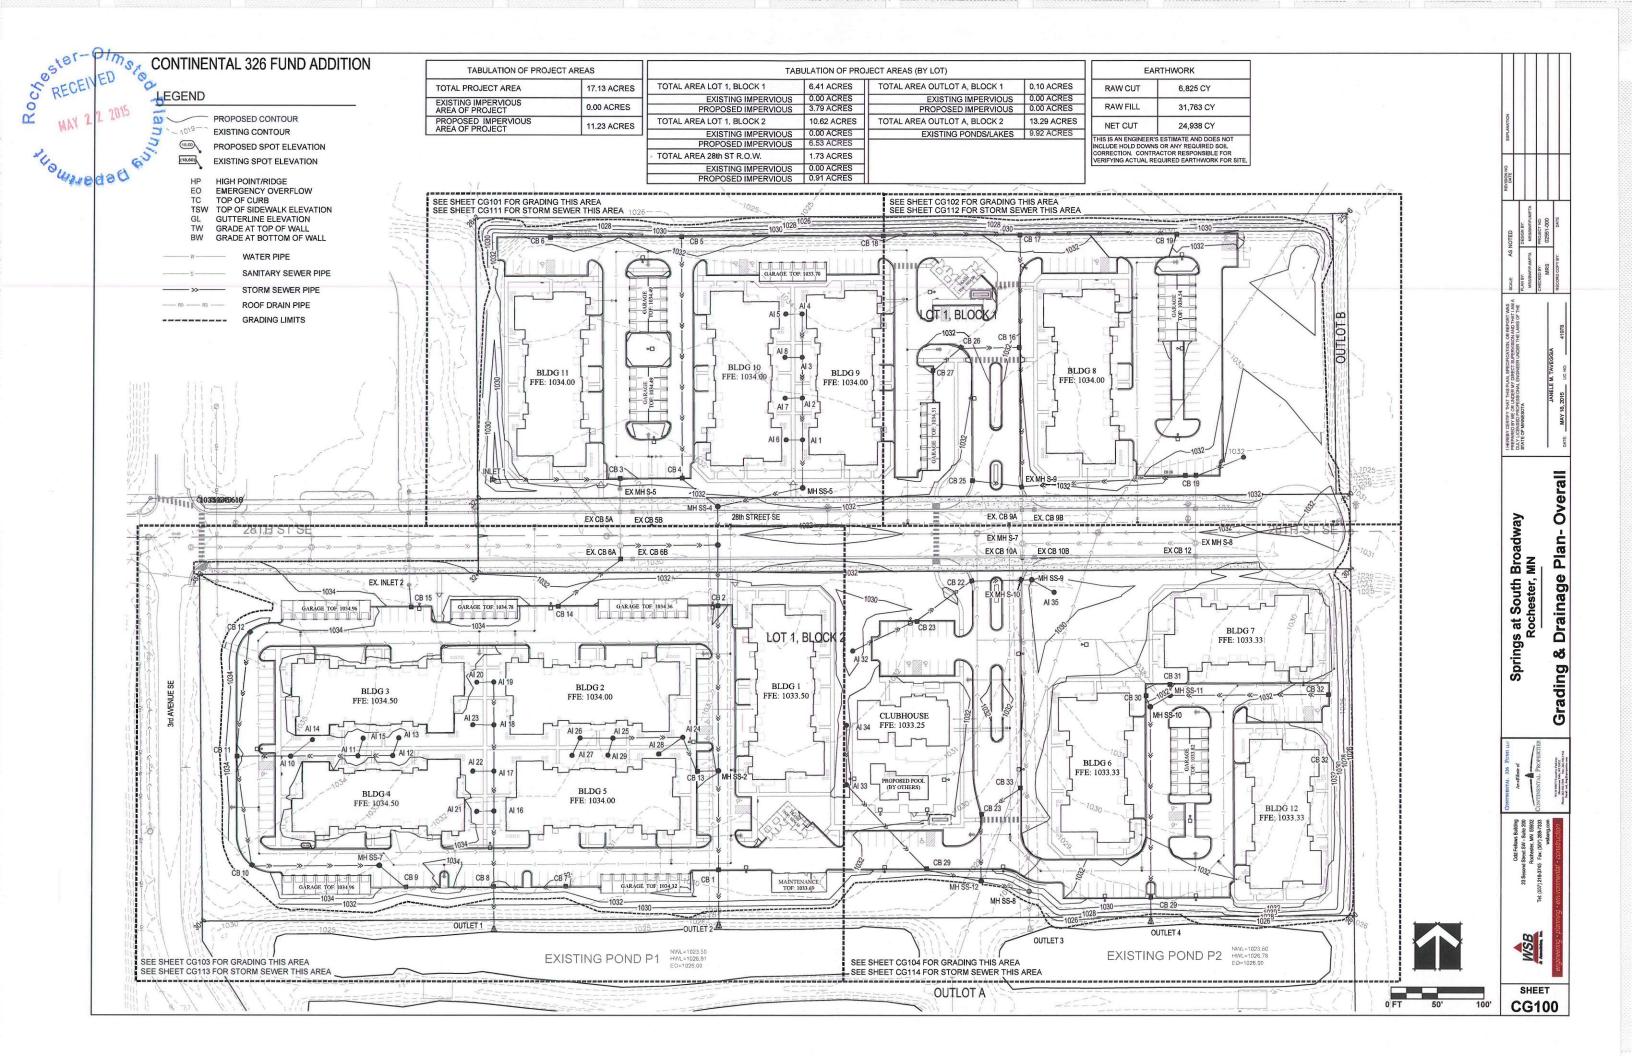

2 chester LANDSCAPE REQUIREMENTS **GENERAL LANDSCAPE NOTES** PEANT SCHEDULE SEE SHEET CJ001 FOR GENERAL CIVIL NOTES. (1) BOULEVARD TREE PER 35 LF OF FRONTAGE ON 28TH STREET SE. CONT QTY 2 1/2" Cal B&B 83 Dependent NORTH SIDE - 942.25": 27 TREES REQUIRED. 28 TREES PROVIDED. ALL PLANTING BEDS. CONTRACTOR TO PROVIDE GRANULAR WEED 2. LANDSCAPE CONTRACTOR SHALL VISIT THE SITE PRIOR TO SUBMITTING A BID TO BECOME FAMILIAR WITH SITE CONDITIONS. PREVENTION IN MULCH BEDS PER MANUFACTURER'S RECOMMENDATIONS. PROVIDED TREES CONTAIN THE FOLLOWING VARIETIES: FALL FIESTA SUGAR MAPLE, IMPERIAL HONEYLOCUST. THORNLESS HAWTHORN, PRAIRIFIRE CRABAPPLE 2 1/2" Cal B&B 29 color / Swamp White Oak 2 1/2" Cal B&B 35 SOUTH SIDE - 1245.15': 36 TREES REQUIRED. 36 TREES PROVIDED. THE LANDSCAPE CONTRACTOR SHALL HAVE ALL UNDERGROUND 5. USE STEEL EDGING IN ALL PLANTING BEDS. COLOR: BLACK PROVIDED TREES CONTAIN THE FOLLOWING VARIETIES: FALL FIESTA SUGAR MAPLE, IMPERIAL HONEYLOCUST, THORNLESS HAWTHORN, PRAIRIFIRE CRABAPPLE UTILITIES LOCATED PRIOR TO ANY DIGGING. THE LANDSCAPE CONTRACTOR SHALL COORDINATE INSTALLATION WITH GENERAL MUIN PO 8' B&B 12 Picea glauca 'Densata' / Black Hills Spruce 20' BUFFERYARD ON EAST LOT LINE OF SITE: NORTH SIDE - 301.21' REQ'D ITEMS: 1 CANOPY TREE, 4 UNDERSTORY TREES, AND 6 SHRUBS. 8° B&B 3. SOD ALL TURF AREAS DISTURBED BY CONSTRUCTION UNLESS CONT 1" Cal B&B NORTH SIDE - PROVIDED ITEMS: 3 CANOPY TREES, 5 UNDERSTORY TREES, AND 10 SHRUBS OTHERWISE NOTED. SOD SHALL BE STAKED ON SLOPES 4H:1V OR SHOWN UNLESS OTHERWISE NOTED ON PLANS. SOUTH SIDE - 371.51' REQ'D ITEMS: 1 CANOPY TREE, 5 UNDERSTORY TREES, AND 8 SHRUBS. SOUTH SIDE - PROVIDED ITEMS: 2 CANOPY TREES, 6 UNDERSTORY TREES, AND 10 SHRUBS. 1 1/2" Cal B&B 55 MX2 Malus x 'Prairifire' / Prairifire Crab Apple 1 1/2" Cal B&B 74 1 1/2" Cal B&B 28 SEE SHEET LS101 FOR LANDSCAPE PLAN THIS AREA SEE SHEET LS102 FOR LANDSCAPE PLAN THIS AREA SHRUBS Juniperus x pfitzeriana 'Sea of Gold' / Sea of Gold Junipe Thuja occidentalis 'Hetz Midget' / Hetz Midget Arborvita Veigela florida 'Java Red' / Java Red Weigela Weigela florida 'Tango' / Tango Weigela () (MX ANNUALS/PERENNIALS

BOTANICAL NAME / COMMON NAME

Antennaria dioica / Common Pussy-toes BLDG 10 BLDG 8 emerocallis x 'Happy Returns' / Happy Returns Daylily Rudbeckia fulgida speciosa 'Viette's Little Suzy' / Coneflowe 1 gal 1 gal 28th STREET SE 28th STREET SE (1) AS AX LDG I BLDG 3 BLDG 2 CLUBHOUSE AX (1) AX) (1 AX BLDG 5 BLDG 4 **EXISTING POND #2 EXISTING POND #1** SEE SHEET LS103 FOR LANDSCAPE PLAN THIS AREA SEE SHEET LS104 FOR LANDSCAPE PLAN THIS AREA

4. PROVIDE THREE-INCH (3") DEPTH DOUBLE SHREDDED HARDWOOD MULCH IN


6. LANDSCAPE CONTRACTOR IS TO COORDINATE WITH GENERAL TO ENSURE DESIGN GRADES ARE MET AS SPECIFIED ON THE GRADING AND DRAINAGE

THE LANDSCAPE CONTRACTOR IS TO FOLLOW ALL LANDSCAPE DETAILS AS

Broadway Plan Springs at South Rochester.



SHEET LS100

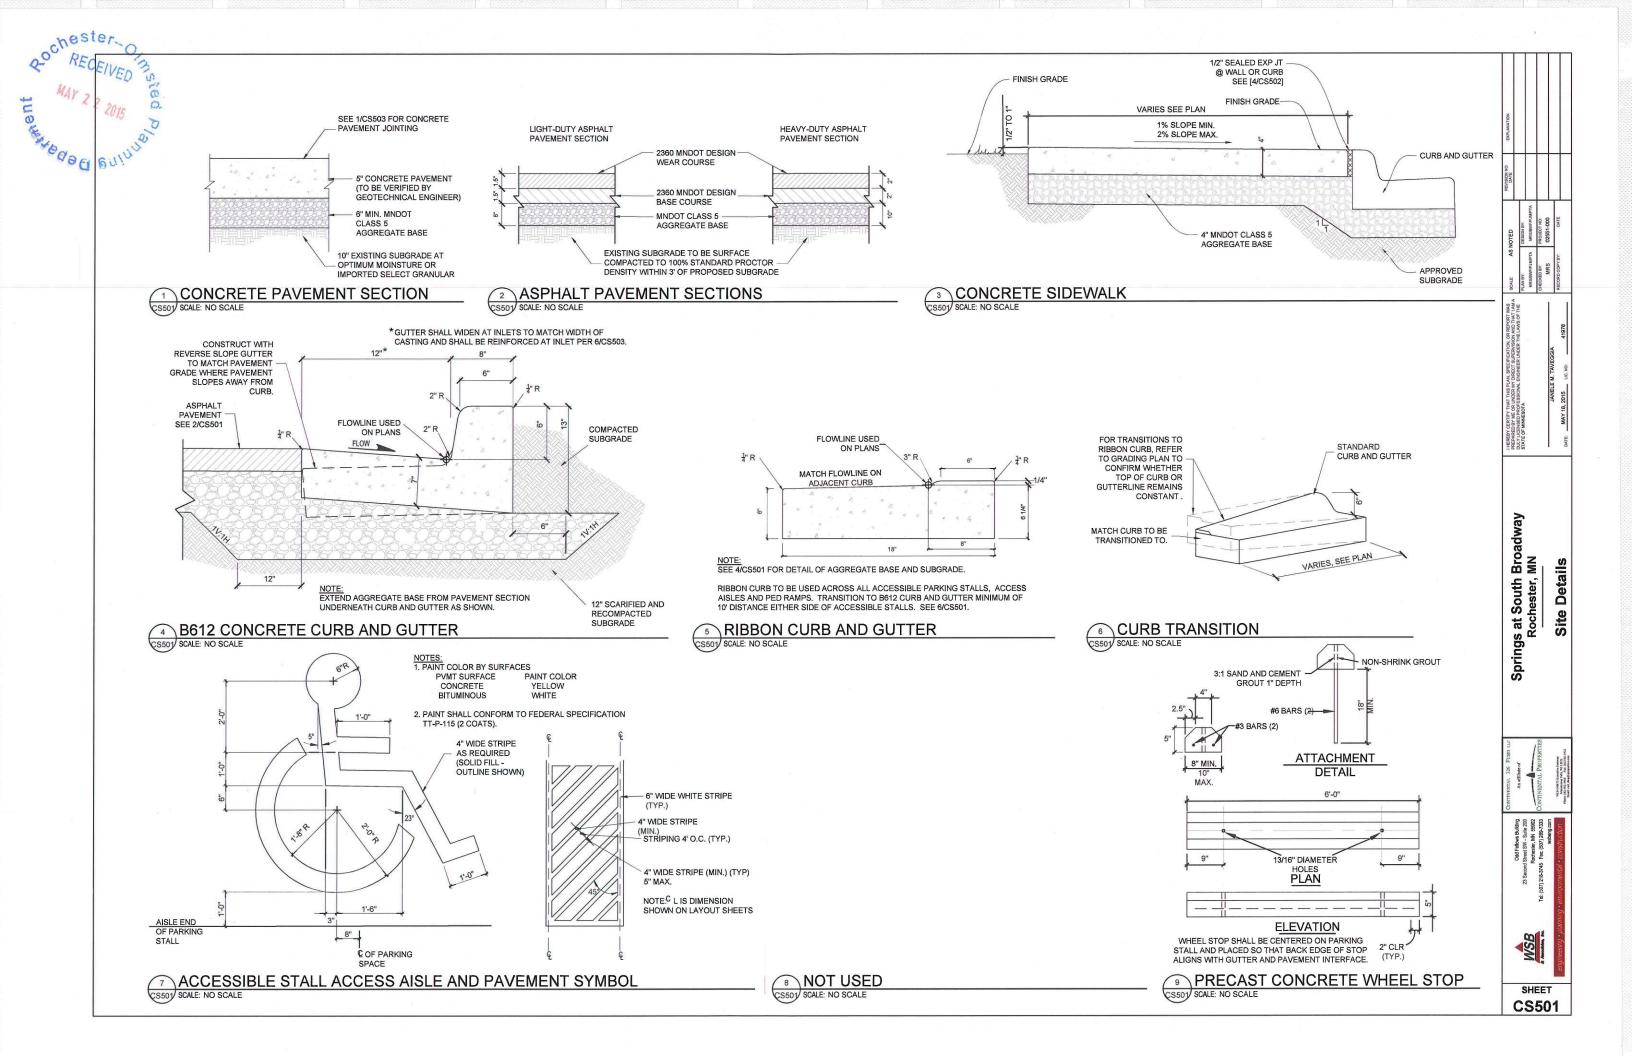

CONSTRUCTION JOINT USE ONLY WHERE WEAKENED PLANE JOINTS WOULD NORMALLY OCCUR

JOINT SEALER

1/4"R

1/4"R

1/2"

NON-BITUMINOUS JOINT FILLER

EXPANSION JOINT
MAXIMUM SPACING 60-0". USE AT ABUTTING BUILDINGS,
CURBS. WALLS AND OTHER STRUCTURES AND AS SHOWN

(SSG) SOALE NO SCALE

JOINT SEALER (TYP)
BITUMINOUS HOT POURED
JOINT SEALANT. USE 0.25in
CLOSED CELL CROSS
LINKED POLYETHYLENE
BACKER

1/2"

TOOLED CONTROL JOINT

1/4"R

- SAWCUT AND TACK COAT EXISTING ASPHALT SURFACE COURSE

EXISTING ASPHALT PAVEMENT

12"

NEW ASPHALT SURFACE COURSE

NEW ASPHALT PAVEMENT

planning Ooppar

S RECEIVED OF RECEIVED

EXISTING BASE COURSES

NEW BASE COURSES

LONGITUDINAL

TRANSVERSE

WALK

CONTRACTION JOINT SPACING

JOINT SPACING FOR STRAIGHT RUNS


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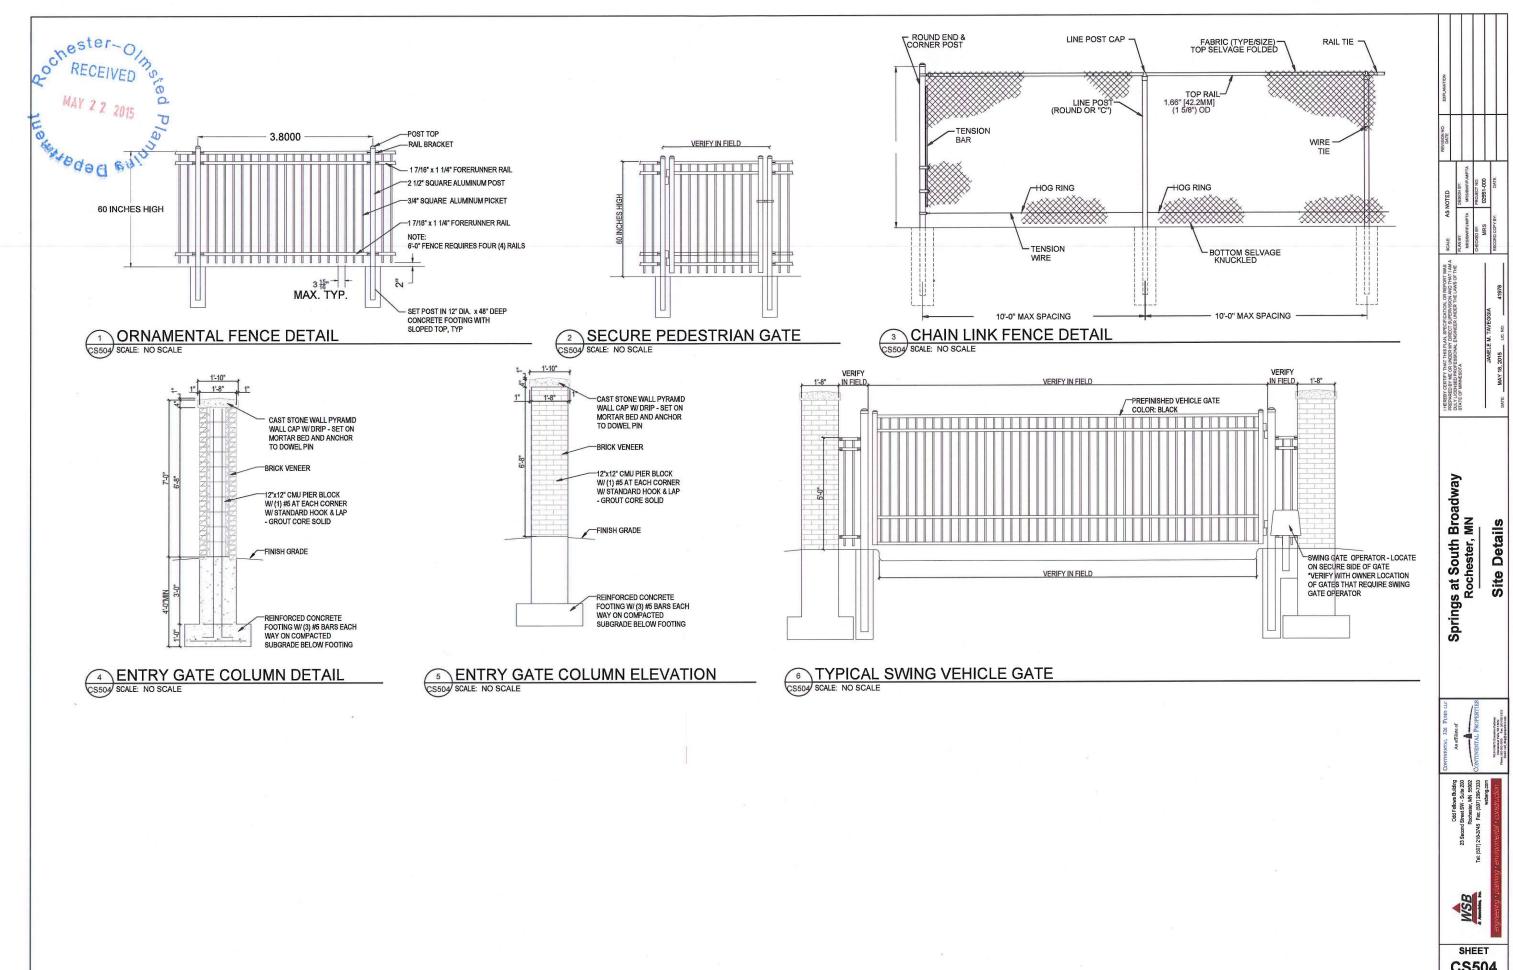
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10, 12'





CS504

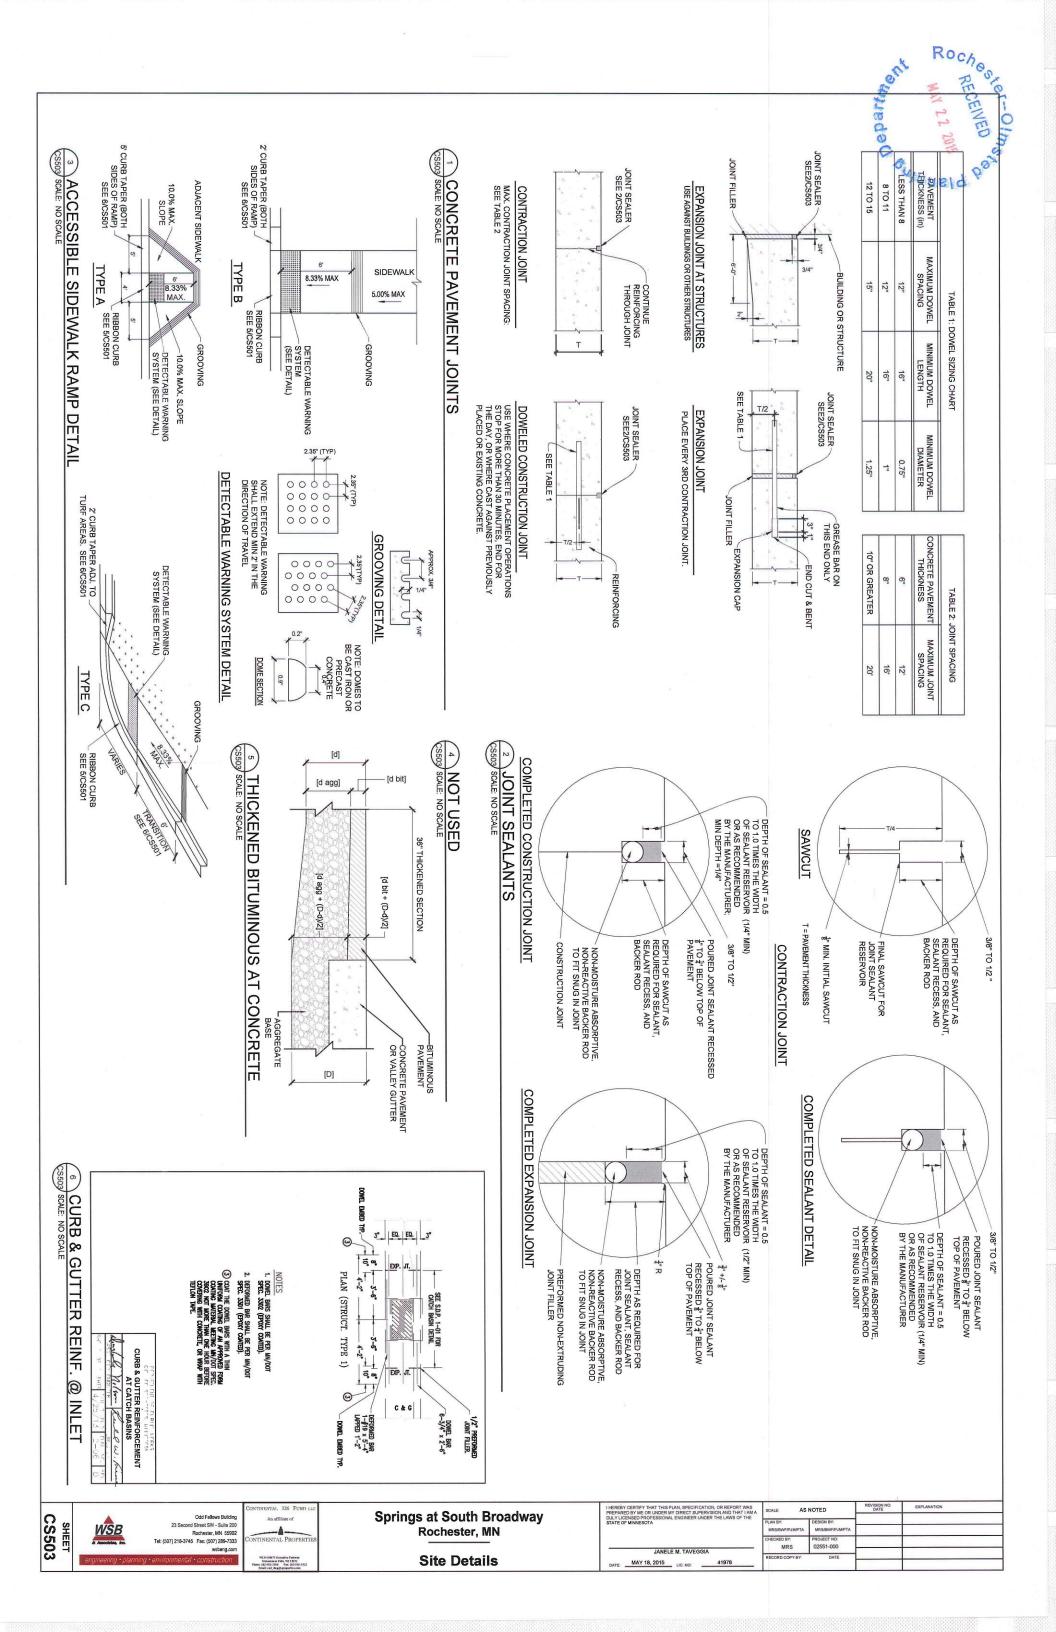

PRIOR TO MULCHING, LIGHTLY TAMP SOIL AROUND THE ROOTBALL INTEX. DO NOT OVER ULTEX. DO NOT OVER COMPACT. AFTER BACKFILLING, POUR WATER AROUND ROOTBALL TO SETTLE THE SOIL. MENDED PLANTING SOIL, SEE-SPECIFICATIONS FOR DETAILS

DIAMETER OF HOLE SHALL BE T TRIPLE THE DIAMETER OF THE TROOTBALL. THE SIDES SHOULD SLOPE GRADUALLY.

RUBBER / NYLON STRAPPING-TIGHTENED ONLY ENOUGH TO PREVENT SLIPPAGE. FLAG FOR VISIBILITY. TREE MUST MEET OR EXCEED

ANSI Z60.1 (AMERICAN STANDARD

FOR NURSERS YTOCK), ORE

DOMINATE LEADER MUST BE

MAINTAINED THROUGH THE

WARRANITY PERIOD. EACH TREE MUST BE PLANTED SUCH THAT THE ROOT FLARE IS VISIBLE AT THE TOP OF THE ROOTBALL AND LEVEL WITH FINISH GRADE.

-4" HIGH EARTH SAUCER BEYOND EDGE OF ROOTBALL, FOR 360°. MULCH RING SHOULD BE MIN. 3" DEEP. KEEP MULCH 4" AWAY FROM TRUNK BASE.

- SET ROOTBALL ON 4"-6"
MOUND OF UNDISTURBED /
NATIVE SOIL TO PREVENT
SETTLING.

501 SCALE NTS METAL STAKES, 2"x24"-LONG DRIVEN BELOW FINISH GRADE.

PRIOR TO MULCHING, LIGHTLY
TAMP SOIL AROUND THE
ROOTBALL IN 8' LIFTS, DO NOT
OVER COMPACT. AFTER
BACKFILLING, POUR WATER
AROUND ROOTBALL TO SETTLE
THE SOIL.
AMENDED PLANTING SOIL, SEE \
SPECIFICATIONS FOR DETAILS DIAMETER OF HOLE SHALL BE-TRIPLE THE DIAMETER OF THE ROOTBALL. THE SIDES SHOULD SLOPE GRADUALLY. RUBBER / NYLON STRAPPING— TIGHTENED ONLY ENOUGH TO PREVENT SLIPPAGE. FLAG FOR VISIBILITY.

FABRIC GUYING STRAP WITH-HOSE CHAFING GUARD

TREE MUST MEET OR EXCEED ANSI
280.1 (AMERICAN STANDARD FOR
NURSERY STOCK), ONE DOMINATE
LEADER MUST BE MAINTAINED
THROUGH THE WARRANTY PERIOD.

CEACH TREE MUST BE PLANTED SUCH THAT THE ROOT FLARE IS VISIBLE AT THE TOP OF THE ROOTBALL AND LEVEL WITH FINISH GRADE. MULCH RING SHOULD BE MIN. 3* DEEP. KEEP MULCH 4" AWAY FROM TRUNK BASE.

-4" HIGH EARTH SAUCER BEYOND EDGE OF ROOTBALL, FOR 360°.

SET ROOTBALL ON 4"-6"
MOUND OF UNDISTURBED /
NATIVE SOIL TO PREVENT
SETTLING.

2 CONIFEROUS TREE PLANTING DETAIL
501 SCALE NTS

EACH TREE MUST BE PLANTED WITH THE —
FIRST MAIN LATERAL ROOT AT FINISH
GRADE. TREES WITH THE FIRST MAIN
LATERAL ROOT NOT VISIBLE WILL BE
REJECTED. VERTICAL SLITS SHOULD BE CUT —
IN REMAINING NON-SYNTHETIC
BURLAP 16" O.C. REMOVE EXCESS SOIL / ROOTS FROM THE TOP OF SOILBALL TO EXPOSE THE FIRST MAIN LATERAL ROOT. PRUNE ALL ENCIRCLING ROOTS.

REMOVE ALL TWINE AROUND THE STEM. ALL SYNTHETIC BURLAP MUST BE

REMOVED. TOP & OF NON-SYNTHETIC BURLAP MUST BE CUT OFF AND REMOVED COMPLETELY, NOT FOLDED DOWN.

3 B&B PLANTING INSTRUCTIONS
501 SCALE-NTS

TOP ½ OF WIRE BASKET MUST BE CUTOFF AND REMOVED COMPLETELY - DO NOT BEND IT BACK.

PLANTING NO.

PLANTING BEDS SHALL BE PREPARED IN THE FOLLOWING MANNIER:

REMOVE ALL EXISTING VEGETATION AND GROUNDCOVER. TREES SHALL HAVE

THE STUMPS REMOVED OR GROUND DOWN.

SPRAY THE PLANTING BED AREA WITH ROUND-UP DURING WARM, DRY

WEATHER. LET IT SIT FOR A MINIMUM OF TWO WEEKS AND THEN

THOROUGHLY REMOVE ALL REMAINING GROUNDCOVER VEGETATION AND

ROTOTILL THE PLANTING BED TO LOOSEN UP THE SOIL. RAKE SMOOTH WHEN DONE AND REMOVE ALL ROCKS AND DEBRIS ENCOUNTERED. INSTALL LANDSCAPE EDGING TO DELINEATE PLANTING BED FROM TURF

AREAS AS INDICATED ON PLANS. SET PLANTS OUT ACCORDING TO PLAN AND ADJUST SPACING AS NEEDED FOR

INSTALL ALL PLANTS AS PER PLANTING PLANS AND DETAILS.

DO NOT ALLOW PLANTS TO DRY OUT DURING INSTALLATION.

ALL PLANT MATERIALS SHALL CONFORM WITH THE MOST RECENT ADDITION OF THE

AMERICAN STANDARD FOR NURSERY STOCK (ANSI Z60) AND SHALL BE OF HARDY

STOCK, FREE FROM DISEASE, DAMAGE, AND DISFIGURATION.

IN INSTANCES WHERE THERE IS A DISCREPANCY BETVEEN THE NUMBER OF

PLANTS IN THE PLANT SCHEDULE AND NUMBER OF PLANTS SHOWN ON THE PLAN,

THE PLAN SHALL GOVERN.

ALL DECIDIOUS TREES NOT PLACED IN PLANTING BEDS SHALL RECEIVE A FOUR ALL DECIDIOUS TREES NOT PLACED IN PLANTING BEDS SHALL RECEIVE A SIX FOOT (4') DIAMETER SHREDDED HARDWOOD MULCH RING, 3" DEPTH. ALL EVERGREEN TREES NOT PLACED IN PLANTING BEDS SHALL RECEIVE A SIX FOOT (6') DIAMETER SHREDDED HARDWOOD MULCH RING, 3" DEPTH. EDGING IS NOT REQUIRED AROUND TREES NOT INSTALLED IN PLANTING BEDS.

BALLED AND BURLAPPED STOCK:

ROOTS OF ALL BALLED AND BURLAPPED STOCK SHALL FILL THE SOIL BALL, BE FREE OF KINKS, CIRCLING AND GRDLING, AND THE UPPERMOST ROOTS SHALL NOT BE MORE THAN FOUR INCHES BELOW THE TOP OF THE SOIL BALL.

TRANSPORT ROOTS SHALL BE SYMMETRICAL AROUND THE TRUNK / STEM OF THE PLANTS. SOIL BALLS MUST BE CENTERED OR NO MORE THAN 10% OFF CENTER.

DIG THE PLANTING PIT TWO TO THREE TIMES WIDER THAN THE SIZE OF THE ROOTBALL AND AT THE SAME DEPTH AT WHICH THEY GREW IN THE NURSERY. SCARIFY THE SIDES AND BOTTOM OF THE PLANTING PIT.

PLACE PLANT IN PLANTING PIT AND SET PLANTS VERTICAL. WHEN MOVING PLANTS, LIFT FROM BENEATH THE ROOT BALL, DO NOT LIFT BY THE TRUNK AND DO NOT BREAK OR LOOSEN THE ROOTBALL.

SET PLANTS ON SOLID, UNDISTURBED SOIL, OR THOROUGHLY COMPACTED BACKFILL SOIL SO THE TOP OF THE ROOTBALL IS SLIGHTLY ABOVE FINISHED GRADE TO EXPOSE ROOTFLAIRS ON ALL B&B TREES TO PREVENT "STEM GIRDLING".

CUT AND REMOVE ALL TWINE AROUND THE TRUNK. PULL BURLAP AWAY FROM TRUNK SO THAT NO BURLAP REMAINS IN THE TOP THREE INCHES OF THE SOIL SURFACE. REMAINING BURLAP SHALL BE SLIT AT SIX INCH INTERVALS AROUND THE CIRCUMFERENCE OF THE ROOTBALL.

BACKFILL PLANTING PIT WITH ORIGINAL SOIL HALFWAY TO THE TOP OF THE ROOTBALL. BREAK UP CLODS OF SOIL. IF SOILS ARE POOR (I.E. HEAVY CLAYS, SAND, OR COMPACTED), BACKFILL CAN BE A MIXTURE OF 1/3 SOIL AMENDMENT MIXED WITH 2/3 ORIGINAL SOIL. DO NO USE PEAT AS PART OF BACKFILL IN CLAY SOILS. REMOVE ALL ROCKS AND DEBRIS FROM BACKFILL AND THEN WATER PLANT AND BACKFILLED AREA TO SETTLE PLANTS AND FILL VOIDS.

REMOVE ALL WIRE BASKETS FROM THE TOP 1/2 OF THE ROOTBALL AND CONTINUE BACKFILLING REMAINING PLANTING PIT WITH ORIGINAL SOIL.

WATER THOROUGHLY A SECOND TIME TO SETTLE PLANTS AND FILL VOIDS WITHIN TWO HOURS OF PLANTING. PLACE SPECIFIED MULCH WITHIN 48 HOURS OF THE SECOND WATERING. PROVIDE SUPPORT IF NECESSARY.

CONTAINER STOCK:
DIG THE PLANTING HOLE TWO TO THREE TIMES WIDER THAN THE SIZE OF THE
CONTAINER, OR TO THE EDGE OF THE PLANTING BED AS INDICATED ON THE
PLANS, AND AT THE SAME DEPTH AT WHICH THEY GREW IN THE NURSERY. FOR
ADDITIONAL PLANTING BED PREPARATION, SEE PLANTING NOTES.

IF ROOTS ARE GROWING IN A SPIRAL AROUND THE SOIL MASS, USE A SHARP KNIFE TO SCORE THE OUTSIDE OF SOIL MASS VERTICALLY, JUST DEEP ENOUGH TO CUT THE NET OF THE ROOTS, AND MAKE A CRISS-CROSS CUT ACROSS THE BOTTOM OF THE SOIL MASS.

SET PLANT ON SOLID UNDISTURBED SOIL OR TH SOIL SO THE TOP OF THE SOIL IS AT FINISHED G TO EXCEED TWO INCHES. 'HOROUGHLY COMPACTED BACKFILL GRADE OR SLIGHTLY ABOVE, NOT

BACKFILL PLANTING BED WITH ORIGINAL SOIL, BREAK UP CLODS OF SOIL, IF SOILS ARE POOR (IE: HEAVY CLAYS, SAND, OR COMPACTED), BACKFILL CAN BE A MIXTURE OF 1/3 SOIL AMENDMENT WITH 2/3 ORIGINAL SOIL, DO NOT USE PEAT AS PART OF BACKFILL IN CLAY SOILS. REMOVE ALL ROCKS AND DEBRIS FROM PART OF BACKFILL IN CLAY SOILS.

SPRING TO MID-SUMMER PLANTING:
FERTILIZE AT THE TIME OF PLANTING WITH A SLOW-RELEASE, BALANCED
FERTILIZER, USE ACCORDING TO MANUFACTURER'S INSTRUCTIONS, MIX
FERTILIZER IN WITH BACKFILL OR BROADCAST IN A DIAMETER AROUND THE PLANT.

LATE SUMMER TO FALL PLANTINGS:
USE A FERTILIZER WITHOUT NITROGEN FOR DECIDUOUS TREES. DO NOT APPLY
ANY FERTILIZER TO EVERGREEN TREES AND SHRUBS PLANTED IN LATE SUMMER
OR EARLY FALL.

SHREDDED WOOD MULCH:
SHRENDED WOOD MULCH SHALL BE INSTALLED AT A 3" COMPACTED DEPTH
PLACED TO THE EDGE OF THE PLANTING BED. PLANTS NOT IN A PLANTING BED
SHALL HAVE A 4" DIA, MULCHED AREA, MULCH SHALL BE PULLED AWAY FROM
DIRECT CONTACT WITH THE TREE TRUNK OR PLANT STEM. MULCHED AREA SHALL
FORM A WELL AROUND PLANTS OR PLANTING BEDS.

REMOVE CONTAINER (BY CUTTING IF NECESSARY).

THOROUGHLY WATER TO SETTLE THE PLANTS AND FILL VOIDS WITHIN TWO HOURS OF PLANTING. INSTALL MULCH WITHIN 48 HOURS OF WATERING.

501 SCALE NTS

PRIOR TO MULCHING, LIGHTLY —
TAMP SOIL ARQUIND THE ROOT
BALL IN "LIFTS" DBRACE SHRUB.
DO NOT OVER COMPACT. WHEN
THE PLANTING HOLE HAS BEEN
BACKFILLED, POUR WATER
ARQUIND THE ROOT BALL TO

4" LAYER OF MULCH. NO MORE — THAN 1" OF MULCH ON TOP OF ROOT BALL. (SEE SPECIFICATION FOR MULCH).

EACH SHRUB SHALL BE PLANTED SO THAT THE ROOT FLARE IS VISIBLE AND LEVEL WITH FINISH GRADE.

— 4" HIGH x 8" ROUND - TOPPED SOIL BERM ABOVE ROOT BALL SURFACE SHALL BE CONSTRUCTED AROUND THE ROOT BALL. BERM SHALL BEGIN AT ROOT BALL PERIPHERY.

AMENDED PLANTING SOIL. SEE SPECIFICATIONS FOR DETAILS

SET ROOTBALL ON UNDISTURBED / NATIVE SOIL TO PREVENT SETTLING.

WSB

LS501 SHEET



Springs at South Broadway Rochester, MN

Landscape Details

MAY 18, 2015 LIC. NO:

AS NOTED



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DES.	DESCRIPTION	L	AMP DATA	VOLT	DEPTH	LIGHTIN	NG FIXTURE	CEILING	WALL	SUSP.	SPECIAL	LAY-IN	CONCEAL	DRYWALL	WALL	SEE
DES.	DESCRIPTION	NO.	TYPE	VOLI	DEPTH	MFR.	CAT. NO.	ö	Š	S	망	≤	8	H	š	NOT
AV3-20	SHOE-BOX (III) FIXTURE ON POLE 20'-0" MOUNTING HEIGHT	1	250 W MH- CLEAR	240	-	US ARCH. VERSALUX	VRS III 250PSMH 1 BLACK PC-240									1,2,3
AV5-20	SHOE-BOX (V) FIXTURE ON POLE 20'-0" MOUNTING HEIGHT	1	250 W MH- CLEAR	240	-	US ARCH, VERSALUX	VRS V 250PSMH 1 BLACK PC-240				0					1,2,3
BV3-20	SHOE-BOX (III) FIXTURE ON POLE 20'-0" MOUNTING HEIGHT	1	150 W MH- CLEAR	240	-	US ARCH. VERSALUX	VRS III 150PSMH 1 BLACK PC-240				0					1,2,3
w	BUILDING WALL PACK	1	150 W MH- CLEAR	120	-	LITHONIA LIGHTING	TWF1-150M		•							2
GB	GARAGE BUILDING WALL PACK	1	(2) 42W TRT FLR	120	-	LITHONIA LIGHTING	WST-2/42- TRT-MD	Г			•	Г				2
F	DECORATIVE POST TOP FIXTURE TYPE 3 - 15' POLE	1	150 W MH- CLEAR	240	-	AMERLUX EXTERIOR	D154-TS20R-PCL/ 150MH-120/ BLK/HR5				0					2

LIGHTING FIXTURE NOTES:

1. PROVIDE DIRECT BURIAL POLE, UNLESS SITE CONDITIONS REQUIRE CONCRETE BASE.

2. PROVIDE PHOTOCELL ON FIXTURE.

3. INSTALL ROADWAY LIGHT POLES 4 FEET BEHIND EDGE OF PAVEMENT OR 2 FEET BEHIND SIDEWALK (TYPICAL).

OVERALL SITE LIGHTING PLAN
1" = 60'-0"

GENERAL NOTES

- INSTALL PRIMARY ELECTRICAL CONDUIT PROVIDED BY "FPL", CONDUIT SHALL BE 3 FEET BELOW FINISHED GRADE. COORDNANTE ROUTE OF CONDUIT WITH FINAL "FPL" DESIGN.
- 2. TV AND PHONE MAY BE IN JOINT TRENCH WITH PRIMARY ELECTRICAL CONDUIT, MAINTAIN 12" SEPERATION.
- INSTALL CONCRETE TRANSFORMER PADS PROVIDED BY "FPL" A' EACH SERVICE LOCATION. MAINTAIN 3' CLEARANCE ON SIDES AN BACK AN 8' CLEARANCE IN FRONT.
- PROVIDE BORE AND OTHER INSTALLATION AS REQUIRED FOR TEMPORARY POWER, COORDIANTE WITH "FPL".

- PROVIDE POOL LIGHTING POWER FROM PANEL 'CH' LOCATED WITHIN CLUBHOUSE -3 #10 & #12G IN 3/4°C. PROVIDE PHOTOCELL / TIMECLOCK CONTROL.
- 5 PROVIDE MAIL KIOSK POWER FROM PANEL 'CH' LOCATED WITH CLUBHOUSE 2 #10 & #12G IN 3/4"C.
- PROVIDE FLAG POLE LIGHTING POWER FROM PANEL 'CH'
 LOCATED WITHIN CLUBHOUSE 3 #10 & #12G IN 3/4°C.
 VERIFYEXACT LOCATION WITH OWNER IN FIELD.
- 7 PROVIDE TRASH COMPACTOR POWER FROM PANEL 'CH' LOCATED WITHIN CLUBHOUSE- 3 #3 & #8G IN 1-1/4"C.
- PROVIDE SITE LIGHTING POWER FROM PANEL 'B20' LOCATED WITHIN BUILDING #1 3 #10 & #126 IN 3/4"C. PROVIDE PHOTOCELL CONTROL ON EACH LIGHT POLE.

- 21) PROVIDE SITE LIGHTING POWER FROM PANEL 'B16' LOCATED WITHIN BUILDING #12 3 #10 & #12G IN 3/4"C. PROVIDE PHOTOCELL CONTROL ON EACH LIGHT POLE.
- 22 PROVIDE SITE LIGHTING POWER FROM PANEL 'B16' LOCATED WITHIN BUILDING #6 3 #10 & #126 IN 3/4"C. PROVIDE PHOTOCELL CONTROL ON EACH LIGHT POLE.

- 36 PROVIDE 'G10' GARAGE PANEL 'GB' POWER FROM PANEL 'B20' LOCATED WITHIN BUILDING #11 3 #6 & #8G IN 1"C.
- PROVIDE SITE LIGHTING POWER FROM PANEL 'B16' LOCATED WITHIN BUILDING #7-3 #10 & #12G IN 3/#'C. PROVIDE PHOTOCELL CONTROL ON EACH LIGHT POLE.

SHEET NOTES

- MAINTAIN FOUR FEET (4'-0") CLEARANCE IN FRONT OF
- PROVIDE SITE LIGHTING POWER FROM PANEL 'CH' LOCATED WITHIN CLUBHOUSE 3 #10 & #12G IN 3/4"C. PHOTOCELL CONTROL ON EACH LIGHT POLE.

- B PROVIDE SIGN LIGHTING POWER FROM PANEL 'CH' LOCATED WITHIN CLUBHOUSE 3 #10 & #12G IN 3/4" C. VERIFY CONTROL WITH OWNER.
- PROVIDE 'GB' GARAGE PANEL 'GB' POWER FROM PANEL 'B20' LOCATED WITHIN BUILDING #2 3 #6 & #8G IN 1"C.
- PROVIDE SITE LIGHTING POWER FROM PANEL 'B20' LOCATED WITHIN BUILDING #2 3 #10 & #126 IN 3/4"C, PROVIDE PHOTOCELL CONTROL ON EACH LIGHT POLE.
- PROVIDE 'G6' GARAGE PANEL 'GB' POWER FROM PANEL 'B20' LOCATED WITHIN BUILDING #2 3 #6 & #8G IN 1"C.
- PROVIDE SITE LIGHTING POWER FROM PANEL 'B20' LOCATED WITHIN BUILDING #3 3 #10 & #126 IN 3/4"C, PROVIDE PHOTOCELL CONTROL ON EACH LIGHT POLE.
- PROVIDE 'G8' GARAGE PANEL 'GB' POWER FROM PANEL 'B20' LOCATED WITHIN BUILDING #3 3 #6 & #8G IN 1"C.
- 15) PROVIDE GARAGE 'E' PANEL 'GB' POWER FROM PANEL 'B20' LOCATED WITHIN BUILDING #4 3 #6 & #8G IN 1"C.
- PROVIDE SITE LIGHTING POWER FROM PANEL 'B20' LOCATED WITHIN BUILDING #4-3 #10 & #12G IN 3/4°C. PROVIDE PHOTOCELL CONTROL ON EACH LIGHT POLE.
- PROVIDE 'G8' GARAGE PANEL 'GB' POWER FROM PANEL 'B20' LOCATED WITHIN BUILDING #5 3 #6 & #8G IN 1"C.
- PROVIDE SITE LIGHTING POWER FROM PANEL 'B20' LOCATED WITHIN BUILDING #5 -3 #10 & #126 IN 3/4°C. PROVIDE PHOTOCELL CONTROL ON EACH LIGHT POLE.
- 19 PROVIDE 'G12' GARAGE PANEL 'GB' POWER FROM PANEL 'B16' LOCATED WITHIN BUILDING #6-3 #6 & #8G IN 1"C.
- 20 PROVIDE MAINTENANCE GARAGE PANEL 'MG' POWER FROM ELECTRICAL METERS LOCATED ON BUILDING #6 3 #1 & #6G IN 1-1/2'C.
- 23) PROVIDE SITE LIGHTING POWER FROM PANEL 'B20' LOCATED WITHIN BUILDING #7 3 #10 & #12G IN 3/4"C. PROVIDE PHOTOCELL CONTROL ON EACH LIGHT POLE.
- 24 PROVIDE SIGN LIGHTING POWER FROM PANEL 'B20' LOCATED WITHIN BUILDING 8 3 #10 & #12G IN 3/4" C. VERIFY CONTROL WITH OWNER.
- (25) PROVIDE ENTRY GATE POWER FROM PANEL '820' LOCATED WITHIN BUILDING 8 3 #10 & #126 IN 3/4"C, PROVIDE ALL ROUGH-IN FOR ENTRY GATE SYSTEM, INCLUDING EXIT VEHICLI DETECTION LOOP.
- PROVIDE MAIL KIOSK POWER FROM PANEL 'B20' LOCATED WITHIN BUILDING 8 2 #10 & #12G IN 3/4"C.
- 27 PROVIDE SITE LIGHTING POWER FROM PANEL 'B20' LOCATED WITHIN BUILDING #8 3 #10 & #12G IN 3/4"C. PROVIDE PHOTOCELL CONTROL ON EACH LIGHT POLE.
- 28 PROVIDE SITE LIGHTING POWER FROM PANEL 'B20' LOCATED WITHIN BUILDING #8 3 #10 & #126 IN 3/4"C. PROVIDE PHOTOCELL CONTROL ON EACH LIGHT POLE.
- 29 PROVIDE 'G12' GARAGE PANEL 'GB' POWER FROM PANEL 'B20' LOCATED WITHIN BUILDING #8 3 #6 & #8G IN 1°C. 30) PROVIDE 'G6' GARAGE PANEL 'GB' POWER FROM PANEL 'B20' LOCATED WITHIN BUILDING #9 - 3 #6 & #8G IN 1"C.
- 31 PROVIDE TRASH COMPACTOR POWER FROM ELECTRICAL METER LOCATED ON BUILDING 9-3 #3 & #8G IN 1-1/4"C.
- PROVIDE SITE LIGHTING POWER FROM PANEL '820' LOCATED WITHIN BUILDING #9 3 #10 & #12G IN 3/4°C, PROVIDE
- PROVIDE 'G6' GARAGE PANEL 'GB' POWER FROM PANEL 'B20' LOCATED WITHIN BUILDING #10 3 #6 & #8G IN 1"C.
- PROVIDE SITE LIGHTING POWER FROM PANEL 'B20' LOCATED WITHIN BUILDING #10 3 #10 & #12G IN 3/4"C, PROVIDE PHOTOCELL CONTROL ON EACH LIGHT POLE.
- PROVIDE 'G10' GARAGE PANEL 'GB' POWER FROM PANEL 'B20' LOCATED WITHIN BUILDING #10 3 #6 & #8G IN 1"C.

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CONTINENTAL PROPERTIES CONTINENTAL 326 FUND LLC W134 N8675 EXECUTIVE PARKWAY MENOMONEE FALLS, WI 53051 262,502,5500 * FAX 262,502,5522



LEEDY & PETZOLD ASSOCIATES, LLC

Consulting Electrical Engineers/Planners 12970 W. Bluemound Road - Suite 101 Elm Grove, Wisconsin 53122 Ph. (262) 860-1544, Fax (262) 860-1566

LPA #8216

05/08/15 CONSTRUCTION BULLETIN #1 05/15/15 CONSTRUCTION BULLETIN #2

CONSTRUCTION **DOCUMENTS**

Drawing Date MARCH 13, 2015

SPRINGS AT SOUTH **BROADWAY** -**CLUBHOUSE**

560 28TH STREET SE ROCHESTER, MN 55904

Project No. 215004.01

SITE LIGHTING PLAN

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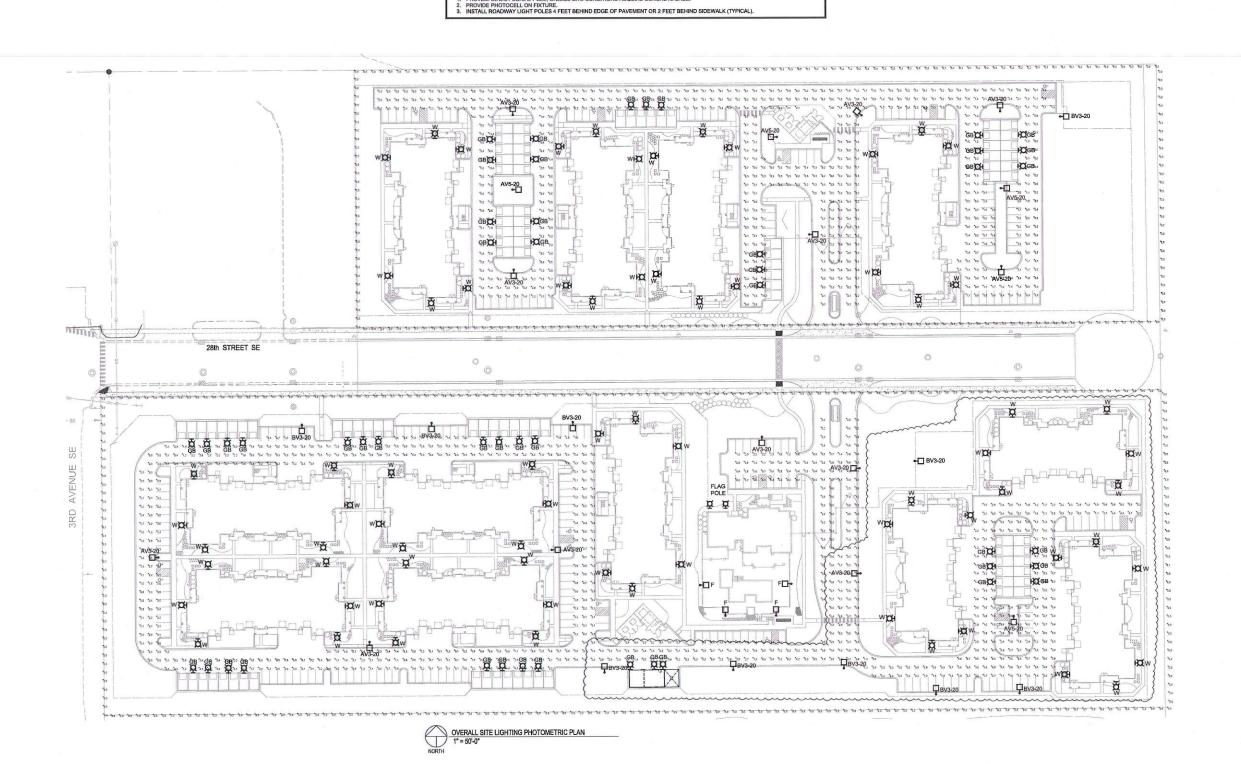
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CIT	TE LIQUEINO FIVE		DE COL	IEDI				SURFACE				RECESS				N
21	TE LIGHTING FIXT	UI	KE 301	IEU	JLE			0			A.		EAL	ALL		\angle
DES.	DESCRIPTION	SCRIPTION LAMP DATA VOLT DEPTH LIGHTING FIXTURE		NG FIXTURE	EILING	WALL	SUSP.	SPECIAL	LAY-IN	CONCEAL	DRYWALI	ᇦ	SE			
DEG.	DESCRIPTION	NO.	TYPE	VOL	DEFIN	MFR.	CAT, NO.	8	ŝ	જ	က်	≤	ö	늅	≩	NO.
AV3-20	SHOE-BOX (III) FIXTURE ON POLE 20'-0" MOUNTING HEIGHT	1	250 W MH- CLEAR	240	-	US ARCH. VERSALUX	VRS III 250PSMH 1 BLACK PC-240				0					1,2,
AV5-20	SHOE-BOX (V) FIXTURE ON POLE 20'-0" MOUNTING HEIGHT	1	250 W MH- CLEAR	240	-	US ARCH. VERSALUX	VRS V 250PSMH 1 BLACK PC-240									1,2
BV3-20	SHOE-BOX (III) FIXTURE ON POLE 20'-0" MOUNTING HEIGHT	1	150 W MH- CLEAR	240		US ARCH. VERSALUX	VRS III 150PSMH 1 BLACK PC-240	П			0					1,2
w	BUILDING WALL PACK	1	150 W MH- CLEAR	120	-	LITHONIA LIGHTING	TWF1-150M									2
GB	GARAGE BUILDING WALL PACK	1	(2) 42W TRT FLR	120	7-	LITHONIA LIGHTING	WST-2/42- TRT-MD				0					2
F	DECORATIVE POST TOP FIXTURE TYPE 3 - 15' POLE	1	150 W MH- CLEAR	240	-	AMERLUX EXTERIOR	D154-TS20R-PCL/ 150MH-120/ BLK/HR5				•	Г				2

PHOTOMETRIC NOTES

- FIXTURES MEET TYPE 3 FIXTURES PER ROCHESTER REQUIREMENTS, L'UMINAIRES WITH TOTAL CUTOFF OF LIGHT OF LESS THAN 90 DEGREE SHALL BE DESIGNED SO THAT THE BARE LIGHT BULB, LAMP, OR SOURCE IS COMPLETELY SHIELDED FROM THE DIRECT VIEW OF AN OBSERVER STANDING AT THE PROPERTY LINE AT A POINT FIVE FEET AROUYE GRADE.*
- THE MAXIMUM PERMITTED DESIGN REQUIREMENTS C CUTOFF LUMINAIRES ARE, PER STANDARD 'R', MAXIM PERMITTED PROPERTY ILLIMINATION OF 0.5fc.





CONTINENTAL PROPERTIES
CONTINENTAL 326 FUND LLC
W134 N8675 EXECUTIVE PARKWAY
MENOMONEE FALLS, WI 53051
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LPA #82

PROFESSIONAL ENGINEER
I hereby certify that this plan, specification report was prepared by me or under my disupervision and that I am a duly Licensed Professional Engineer under the laws of to State of Minnesota.

Print Name: JAMES ROBERT HAUG

Signature: JAMES ROBERT HAUG

Signature: JAMES ROBERT HAUG

Signature: JAMES ROBERT HAUG

Revisions

↑ 05/08/15 CONSTRUCTION BULLETIN #1

↑ 05/15/15 CONSTRUCTION BULLETIN #2

CONSTRUCTION DOCUMENTS

Drawing Date MARCH 13, 2015

SPRINGS AT SOUTH BROADWAY -CLUBHOUSE

560 28TH STREET SE ROCHESTER, MN 55904

Project No.


215004.01

SITE PHOTOMETRIC PLAN

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Sheet No. E3.1.11



PROVIDE FLASHING AS REQUIRED TO PREVENT TH PENETRATION OF WATER THROUGH THE EXTERIO SHELL OF THE BUILDING.

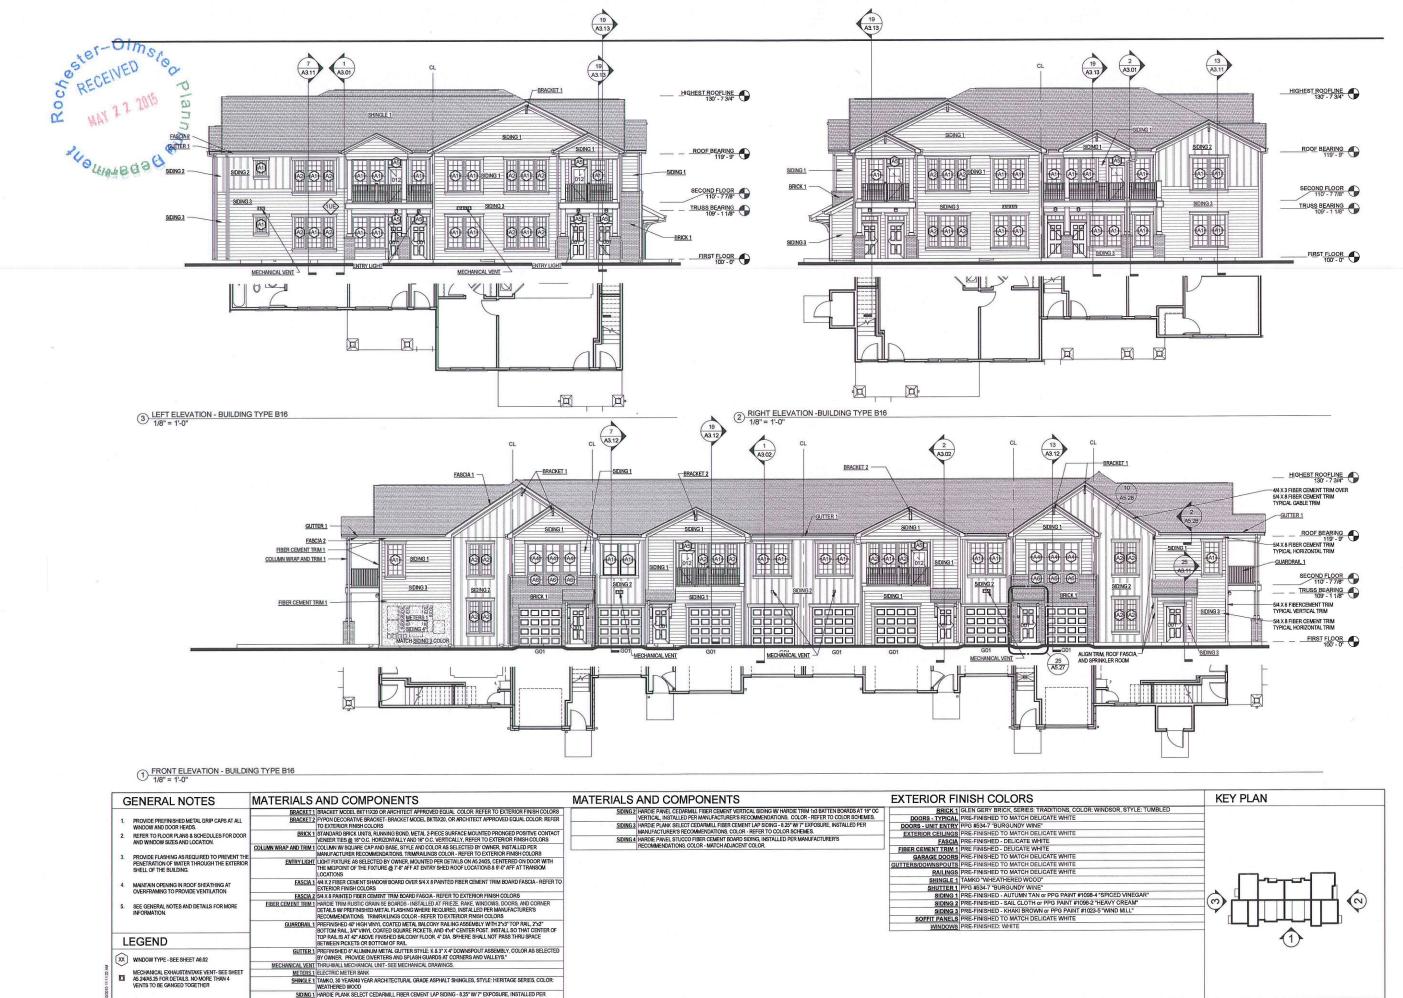MAINTAIN OPENING IN ROOF SHEATHING AT OVERFRAMING TO PROVIDE VENTILATION.

SEE GENERAL NOTES AND DETAILS FOR MORE INFORMATION

WEATHERED WOOD

SIDING 1 HARDIE PLANK SELECT CEDARMILL FIBER CEMENT LAP SIDING - 8.25" W/7" EXPOSURE, INSTALLED PER

LEGEND

(XX) WINDOW TYPE - SEE SHEET A6.02 MECHANICAL EXHAUST/INTAKE VENT- SEE SHEET
A5.24/A5.25 FOR DETAILS, NO MORE THAN 4
VENTS TO BE GANGED TOGETHER

CONTINENTAL PROPERTIES CONTINENTAL 338 FUND LLC
W134 N8675 EXECUTIVE PARKWAY
MENOMONEE FALLS, WI 53051
262.502.5500 * FAX 262.502.5522 Revisions CONSTRUCTION **DOCUMENTS** Drawing Date MAY 13, 2015 SPRINGS AT SOUTH **BROADWAY**

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Rochester, MN

Project No.

215004.01

Sheet Title

EXTERIOR ELEVATIONS -BUILDING TYPE B16

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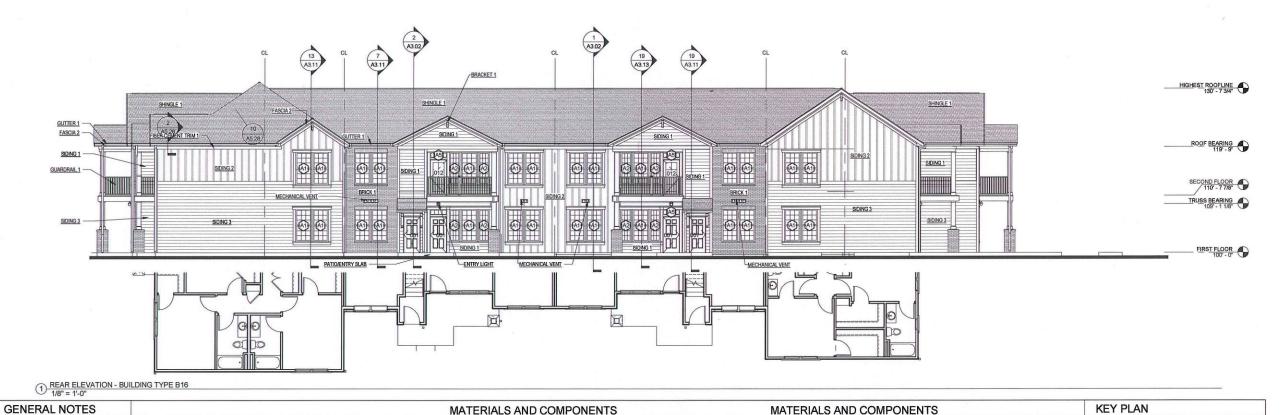
44 East Mifflin Street, Suite 700, Madison, Wisco Telephone 608.283,6300 Fax 608.283,6317 Sheet No.

A2.C.1

Sester-Olmorio The Markage A. FASCIA 1 FASCIA 2 GUTTER 1 ROOF BEARING 119' - 9" ROOF BEARING ROOF BEARING ROOF BEARING SIDING 1 SIDING 1 FIBER CEMENT TRIM 1 SIDING 1 SECOND FLOOR 110' - 7 7/8" SECOND FLOOR SECOND FLOOR σп **GUARDRAIL 1** SIDING 3 BRICK 1 FIBER CEMENT TRIM PATIO/ENTRY SLAB PATIO/ENTRY SLAB FIRST FLOOR FIRST FLOOR 8 PARTIAL ELEVATION - D1 2 PARTIAL ELEVATION - A1 7 PARTIAL ELEVATION - C2 1/8" = 1'-0" 3 PARTIAL ELEVATION - A2 4 PARTIAL ELEVATION - B1 5 PARTIAL ELEVATION - B2 6 PARTIAL ELEVATION - C1



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BRACKET I BRACKET MODEL BKT11X20 OR ARCHITECT APPROVED EQUAL COLOR: REFER TO EXTERIOR FINISH COLORS

PROVIDE PREFINISHED METAL DRIP CAPS AT ALL WINDOW AND DOOR HEADS.

REFER TO FLOOR PLANS & SCHEDULES FOR DOOR AND WINDOW SIZES AND LOCATION.

PROVIDE FLASHING AS REQUIRED TO PREVENT THE PENETRATION OF WATER THROUGH THE EXTERIOR SHELL OF THE BUILDING.

MAINTAIN OPENING IN ROOF SHEATHING AT OVERFRAMING TO PROVIDE VENTILATION.

SEE GENERAL NOTES AND DETAILS FOR MORE INFORMATION.

LEGEND

(XX) WINDOW TYPE - SEE SHEET A6.02 MECHANICAL EXHAUST/INTAKE VENT- SEE SHEET
AS 24/AS 25 FOR DETAILS. NO MORE THAN 4
VENTS TO BE GANGED TOGETHER BRACKET 1 BRACKET MODEL BRITTINZÓ OR ARCHITECT APPROVED EQUAL. COLOR: REFER TO EXTERIOR FINISH COLORS
BRICK I STANDARD BRICK UNTS, RUMAINIS BOND, METAL 2-PIECE SURFACE MOLNITED PROVISED POSTIVE CONTACT
VENERA TIES @ 16" O.C. HORIZONTALLY AND 16" O.C. VERTICALLY, REFER TO EXTERIOR FINISH COLORS
ENTRY LIGHT UNTER THE S. BEJECTED BY OWNER, MOUNTED FER DETAILS ON AS 224Z, CENTRERED ON DOOR WITH
THE MIDPOINT OF THE FIXTURE @ 7-8" AFF AT ENTRY SHED ROOF LOCATIONS 8 9-0" AFF AT TRANSOM
LOCATIONS

FASOL 1 444 X 2 FIBER CREMENT SHADOW BOARD OVER 514 8 PAINTED FIBER CEMENT TITM BOARD FASCIA - REFER
TO EXTERIOR FINISH COLORS
FASOL 2 544 X 8 PAINTED FIBER CREMENT TIMM BOARD FASCIA - REFER TO EXTERIOR FINISH COLORS
CEMENT TIMM 1 MARBIET TRIM RELICIC GRAIN SE FLORAGEN, INSTALL I FOR FIRE FER MINDOWS, DOORS AND CORNER.

EASCIA 2 SAX AS PANIED FIBER CEMENT TRIM BOARD FASCIA - REFER TO EXTERIOR FINISH COLORS

FIBER CEMENT TRIM I HARDIE TRIM MUSTIC GRAIN SE BOARDS - INSTALLED AT FRIEZE, RAKE, WINDOWS, DOORS, AND CORNER
DETAILS WE PREFINISHED METAL FLASHIAN WHERE REQUIRED, NISTALLED PER MANIELPO CORNER
DETAILS WE PREFINISHED METAL FLASHIAN WHERE REQUIRED, NISTALLED PER MANIELPOTEMENT,

GUIARDRAIL. PREFINISHED OF "HIGH HIND COATED METAL BOARD FOR THIS HIS COLORS

GUIARDRAIL. 34" VINTI. COATED SOLARS PICKETS, AND 4"A" CENTER POST. INSTALL SO THAT CENTER OF

TOP PARIL SAT 4" AND VERHINGED BALCONY FLOOR 4" DIAS PHERE SHALL NOT PASS THAT SPACE

BETWEEN PICKETS OR BOTTOM OF RAIL.

GUITTET. PREFINISHED OF ALLAINIAM METAL GUITTER STYLE. K 8, 7" X 4" DOWNSPOUT ASSEMBLY, COLOR AS SELECTED

BY OWNER. PROVIDE DIVERTERS AND SPLASH GUARDS AT CORNERS AND VALLEYS."

MECHANICAL VENT THRUWALL MECHANICAL UNIT. SEE MECHANICAL DRIVINISS.

METHALISM, SALE PRITTS TOORS AND PATIL SHOOM PRINSH CONCRETE, SALED.

SHINGLE I TAMKO, 30 YEARAW CHAR ACHITECTURAL GRADE ASPHALT SHINGLES, STYLE. HERITAGE SERIES, COLOR.

WEATH-REDE PLANK SELECT CEDARMILL FIBER CEMENT LAFS SIDING W HARDIE TRIM 132 BATTEN BOARDS AT 16" CO.

VERTILES OF MANIEL SET OF SALED AND SPLASH COLOR SCHEMES.

SIDING 2 HARDIE PANIEL CEDARMILL FIBER CEMENT VERTICAL SIDING W HARDIE TRIM 132 BATTEN BOARDS AT 16" CO.

VERTILES OF MANIEL CEDARMILL FIBER CEMENT VERTICAL SIDING W HARDIE TRIM 132 BATTEN BOARDS AT 16" CO.

VERTILES OF MANIEL CEDARMILL FIBER CEMENT VERTICAL SIDING W HARDIE TRIM 132 BATTEN BOARDS AT 16" CO.

VERTILES OF MANIEL CEDARMILL FIBER CEMENT VERTICAL SIDING W HARDIE TRIM 132 BATTEN BOARDS AT 16" CO.

SIDING 3 HARDIE PLANK SELECT CEDARMILL FIBER CEMENT LAP SIDING - 8.25" W/7" EXPOSURE, INSTALLED PER MANUFACTURER'S RECOMMENDATIONS, COLOR - REFER TO COLOR SCHEMES.

EXTERIOR FINISH COLORS

BRICK! GLEN GERY BRICK, SERIES: TRADITIONS, COLOR: WINDSOR, STYLE: TUMBLED DOORS - TYPICAL, PRE-FINISHED TO MATCH DELICATE WHITE

DOORS - LIWIT ENTRY PRO #534.7 "BURGUNDY WINE"

EXTERIOR CEILINGS | PRE-FINISHED TO MATCH DELICATE WHITE

FIBER CEMENT TRIM | PRE FINISHED - DELICATE WHITE

FIBER CEMENT TRIM | PRE FINISHED - DELICATE WHITE

GARAGE DOORS | PRE-FINISHED TO MATCH DELICATE WHITE

GUTTERS/DOWNSPOUTS | PRE-FINISHED TO MATCH DELICATE WHITE

SHINGLE | TAMKO: "WHEATHERED WOOD"

SHUTTEN! | PRO #534.7 "BURGUNDY WINE"

SIDING | PRE-FINISHED - AUTUMN TAN or PPG PAINT #1098.4 "SPICED VINEGAR"

SIDING | PRE-FINISHED - AUTUMN TAN OR PPG PAINT #1098.2 "HEAVY CREAM"

SIDING | PRE-FINISHED - SAIL CLOTH or PPG PAINT #1098.2 "HEAVY CREAM"

SIDING | PRE-FINISHED - MATCH DELICATE WHITE

SOFFIT PANELS | PRE-FINISHED TO MATCH DELICATE WHITE

WINDOWS | PRE-FINISHED TO MATCH DELICATE WHITE

EXTERIOR FINISH COLORS

Revisions

CONSTRUCTION **DOCUMENTS**

Drawing Date MAY 13, 2015

SPRINGS AT SOUTH **BROADWAY**

Rochester, MN

Project No.


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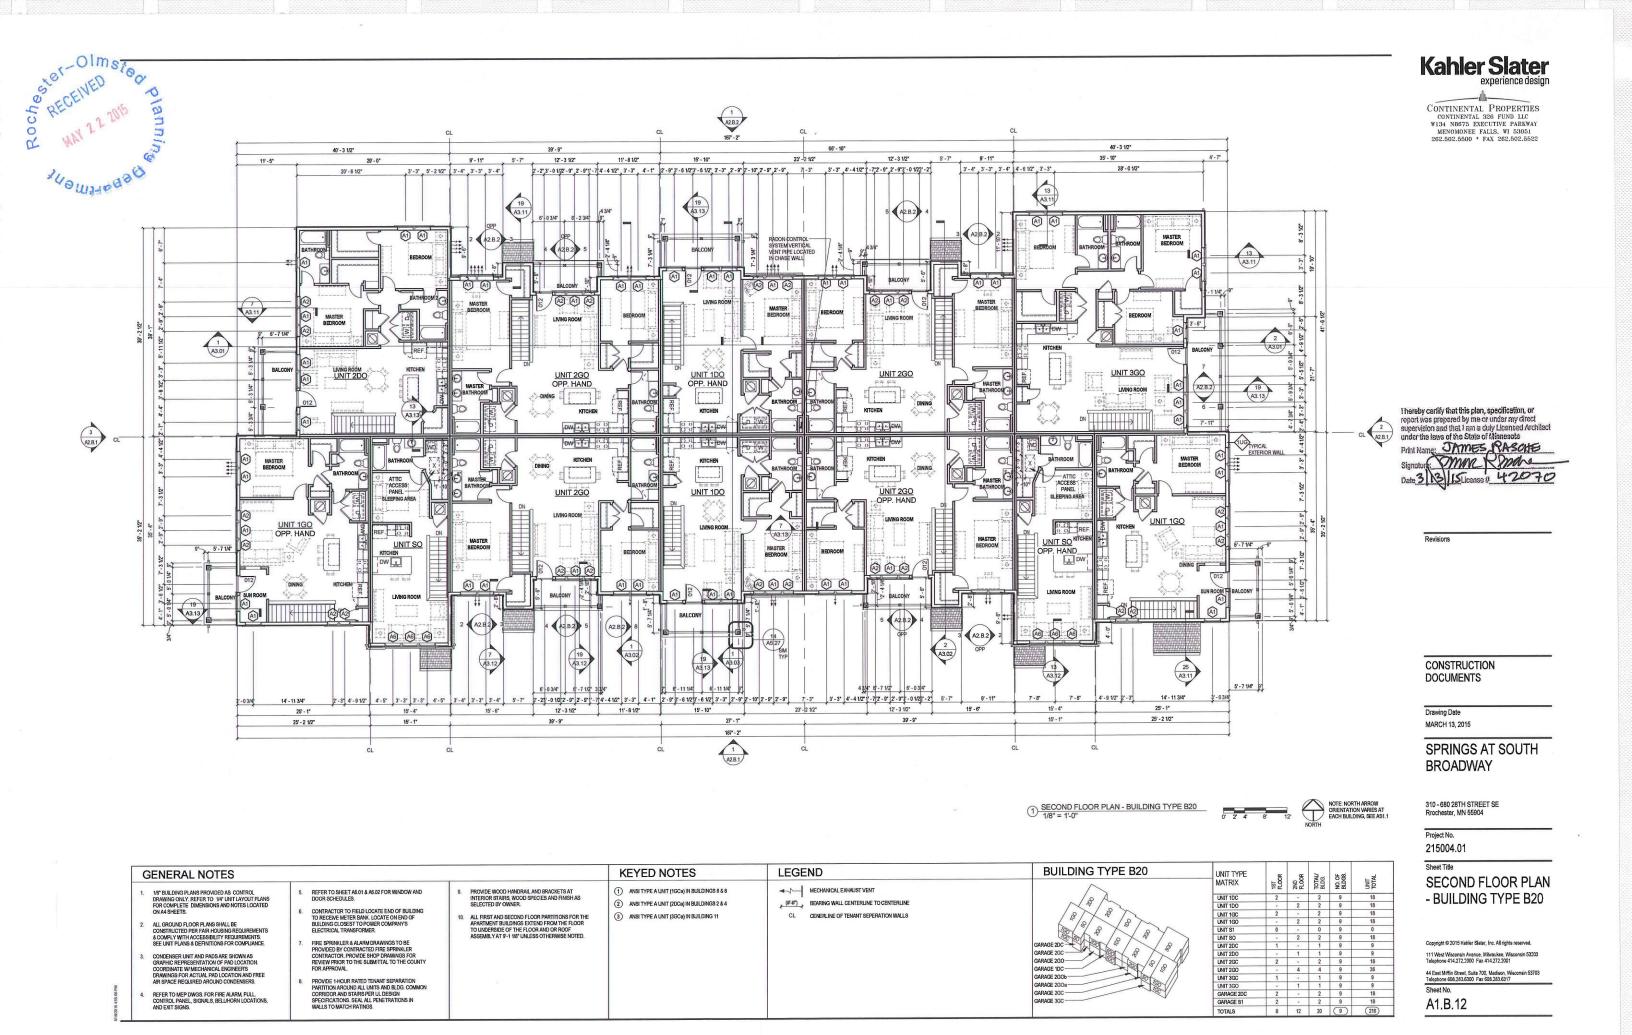
Sheet Title

EXTERIOR ELEVATIONS -BUILDING TYPE B16


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Sheet No. A2.C.2



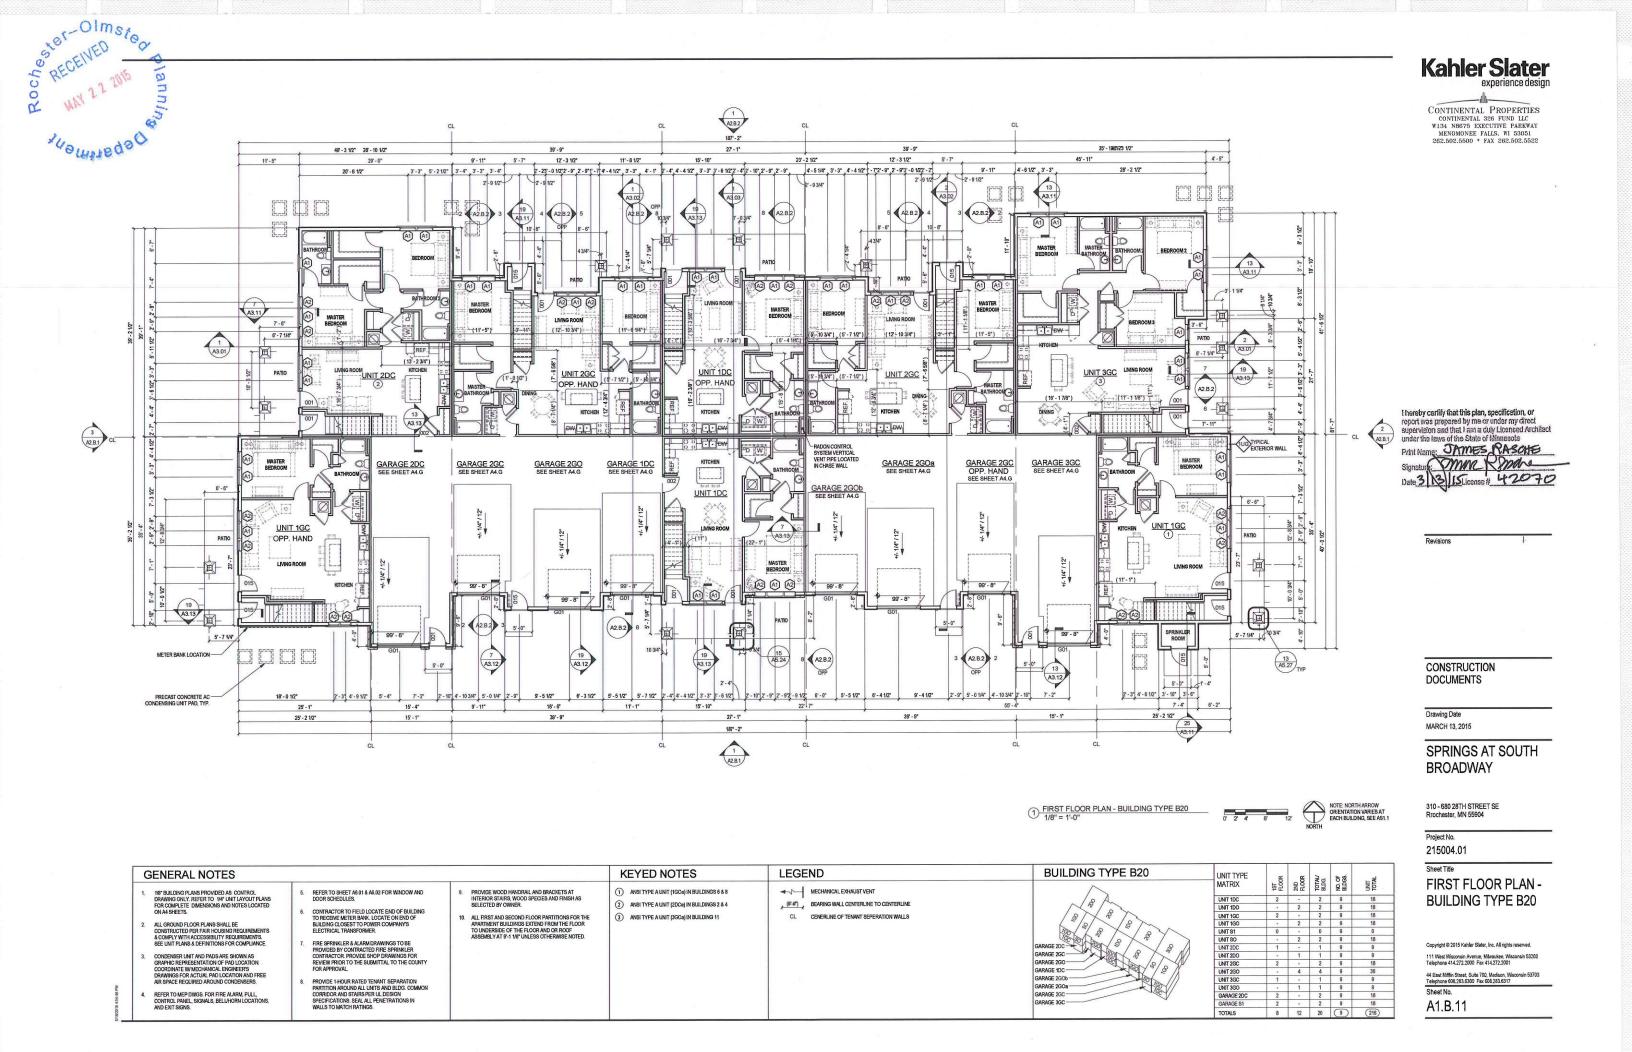

Ster-Olmston Pinnis S RECEIVED Pinnis Walls 22 700 Pinnis

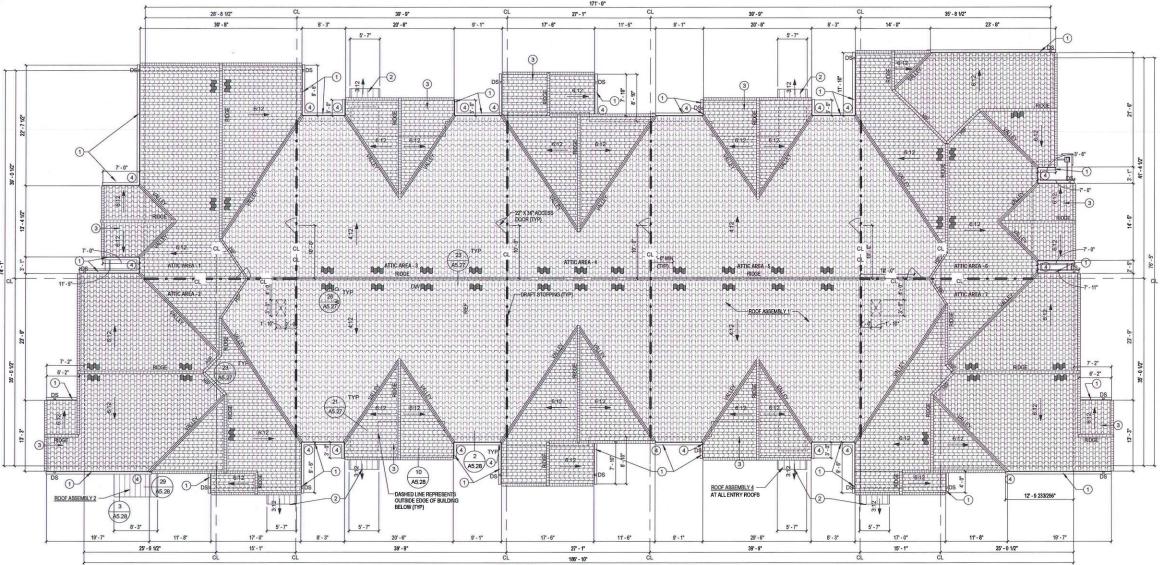

1 ROOF PLAN - BUILDING TYPE B4

GENERAL NOTES	ROOF KEYNOTES	ROOF LEGEND	ATTIC VEN	TILATION	VISCHE	DULI	E			MATERIALS AND COMPONENTS
	TION IS AT FULL DEPTH REQUIRED TO MEET IX EXTERIOR PERIMETER FOR FULL IT GUTTER 1: PERHAMBHED METAL GUTTER AND DOWNSPOUT WITH SPLASH GLIARDS, UNLESS OTHERWISE NO	DS DOWNSPOUT - CONNECT TO STORM SEWER - REFER TO CIVIL	AREA	(SQ FT) REQ	ENTED AREA . (1/300) (SQ IN)	REQ*	(50%) (SQ I	IN) SOF	ACT*** (LINEAL FEET)	OSB ROOF SHEATHING WITH METAL "1" CLIPS, PRE-ENGINEERED WOOD TRUSSES AT 24" O.C., SEE STRUCTURAL DRAWINGS FOR CLIPS AND TO MEET 2010 FLORIDA BUILDING CODE, R-30 BLOWN INSULATION
SPACE BELOW THE ROOF TILES, PROVIDE SOFFIT VENTS W/INSECT SCREENS AS WELL AS VENTED EAVE CLOSURES FOR THE ROOF 11. ENSURE ALL SPRINKLER	LINES AND HEADS ARE FULLY COVERED BY ROTECT PIPES FROM FREEZING. WITH SPLASH GUARDS, UNLESS OTHERWISE NO. SEE BULDING ASSEMBLIES AND COMPONENTS LEGEND ON WALL SECTIONS SHEETS FOR ADDITIONAL INFORMATION. PREFINISHED METAL SHED ENTRY ROOF BELOW. 3. R-30 BLOWN INSULATION AROUND SPRINKLER ILE AND HEAD IS INSULATED AND THAT FULL DEPTH AND COVERY IS PROVIDED. 4. PROVIDE SPLASH GUARDS @ ALL VALLEYS (TYP.)	22" x 36" LOCKABLE ATTIC ACCESS PANEL REFER TO GETAL 3MAS 31 DRAFTSTOPPINGIN ATTIC AREA REFER TO FIRE BLOCKING AND DRAFTSTOPPING NOTES ON SHEET GO.20 22" x 36" ACCESS DOOR INSTALLED VERTICALLY IN DRAFTSTOPPING CONCRETE BARREL ROOF TILES PREFINISHED METAL STANDING SEAM ROOF ALUMINUM VENTED ROOF TILE	50% OF TOT SOFFIT (LOV	1992 1992 1995 1995 1995 1995 1995 1995 1995 1995 1996 19	620 792 1223 926 11223 786 780 786 790 EE CALCULATED B'LYING SUM BY 144 D AREA IS RECUIS THIS VENTED ARE CALCULATED B'D DWE EE CALCULATED B'D DWE EE CALCULATED BY DWE EEL VENTED ARE CALCULATED BY MUX	310 396 611.5 463 611.5 383 395 Y MULTIPYI SQ IN/SQ P RED AT THE PROVIDED, EA SHALL B DING THE TOT/	VERIFY VERIFY VERIFY VERIFY VERIFY VERIFY VERIFY VERIFY THE ACTU FILL FILL FILL FILL FILL FILL FILL FIL	310 396 611.5 463 611.5 383 395 UAL ATTIC / 1) AND 50% ED NET FRE AT THE SO	34 44 5 68 5 151 5 68 43 44 AREA (SQ FT) IN IS REQUIRED THE EE AREA IS 1/150 OF FEFT. REQUIRED VENTILATION B	VAPOR RETARDER ROOF ASSEMBLY.2 STANDING METAL SEAM ROOF PANELS, 40 MIL SELF ADHERED MEMBRANE, 127 OSB ROOF SHEATHING WITH METAL. "I** CLIPS, WOOD FRAMING OR PRE-ENOINEERED WOOD TRUSSES AT 2° O.C., SEE STRUCTURAL, DRAWINGS FOR CLIPS AND TO MEET 2016 FLORIDA BULLINDS CODE, R30 BLOWN BUSLATION, VAPOR RETARDER ROOF ASSEMBLY.4 STANDING SEAM ROOF PANELS, 158 FELT PAPER, 1902* EXTERIOR GRADE PLYWOOD ROOF SHEATHING WITH METAL. "I** CLIPS & PAINTED UNIDERSIDE, EXPOSED STAINED CEDAR RAFTERS AT 16" O.C., SEE STRUCTURAL DRAWINGS FOR CLIPS AND TO MEET 2010 FLORIDA BUILDING CODE

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CONTINENTAL PROPERTIES
CONTINENTAL 305 FUND LLC
W134 N8675 EXECUTIVE PARKWAY
MENOMONE FALLS, WI 53051
262.502.5500 * FAX 262.502.5522



Revisions

CONSTRUCTION DOCUMENTS

Drawing Date JULY 30, 2014

SPRINGS AT ESTERO -BUILDING TYPE B4 BUILDING 11

11101 EVERBLADES PARKWAY ESTERO, FL 33928

Project No.

214006.02

Sheet Title ROOF PLAN -BUILDING TYPE B4


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Sheet No.

A1.B.13



GARAGE 2GOa – GARAGE 2GOb – GARAGE 2GOb – GARAGE 2GOa –

GARAGE 2GC -GARAGE 3GC -

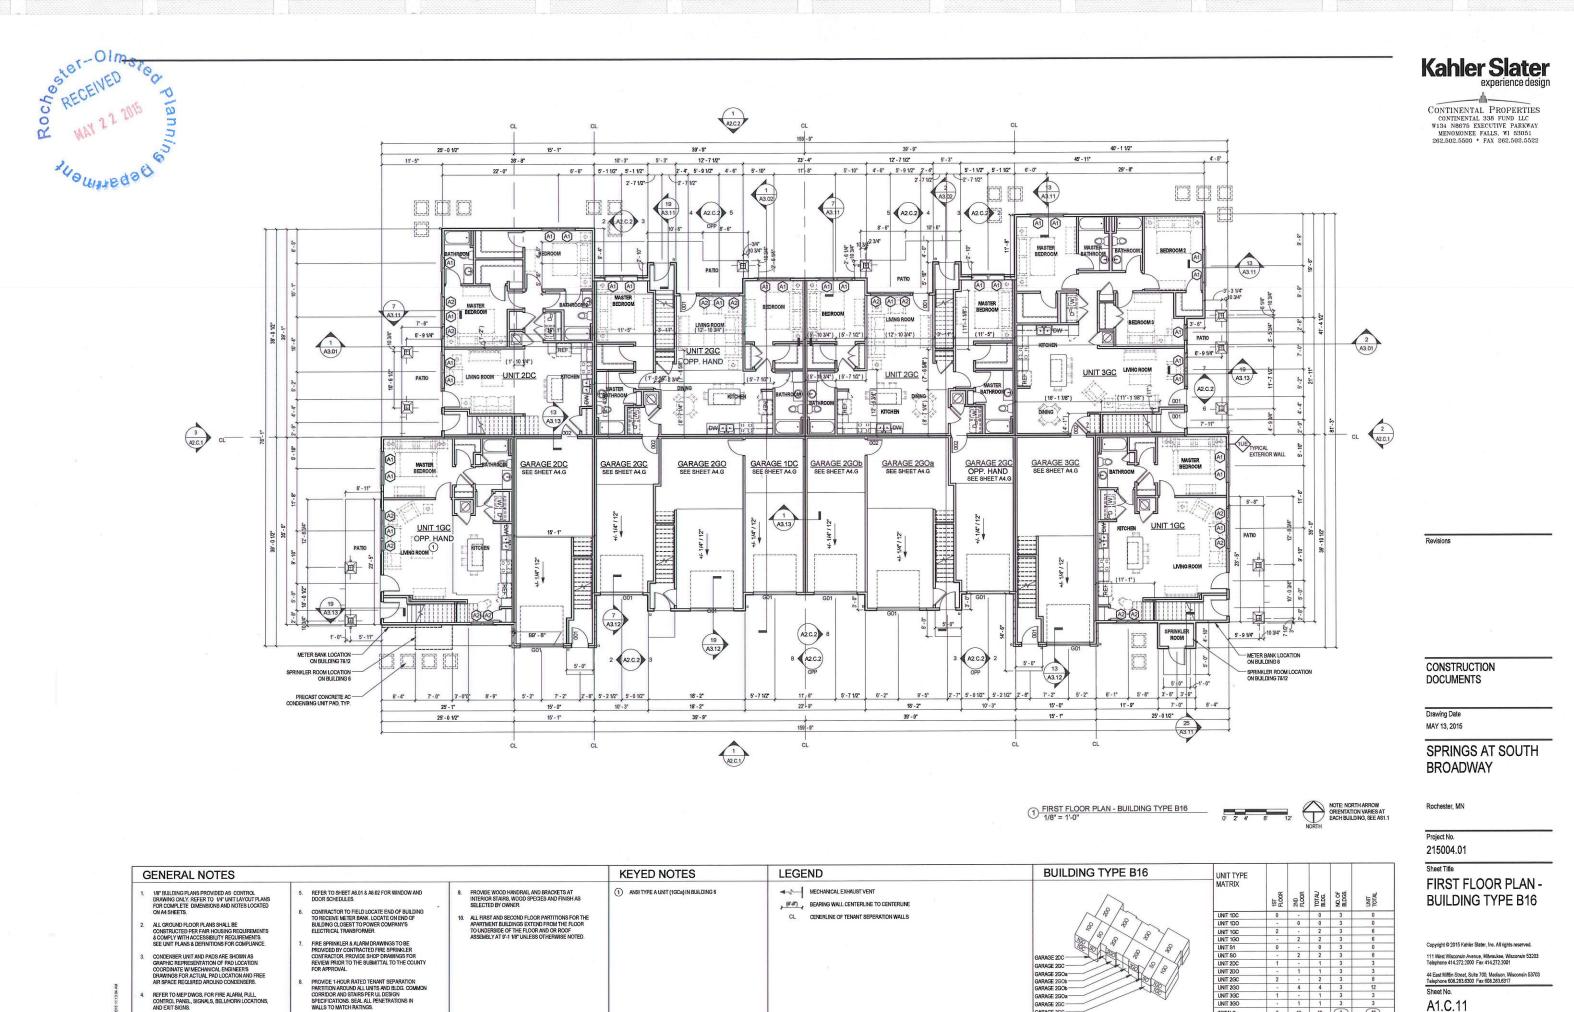TOTALS

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A1.C.11


REFER TO MEP DWGS, FOR FIRE ALARM, PULL, CONTROL PANEL, SIGNALS, BELUHORN LOCATIONS, AND EXIT SIGNS.

PROVIDE 1-HOUR RATED TENANT SEPARATION PARTITION AROUND ALL UNITS AND BLDG. COMMON CORRIDOR AND STAIRS PER UL DESIGN SPECIFICATIONS, SEAL ALL PENETRATIONS IN WALLS TO MATCH RATINGS.

Seter-Olmstonnis RECEIVED Plannis Plan

3 A2.C.1 Kahler Slater experience design

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1) SECOND FLOOR PLAN - BUILDING TYPE B16

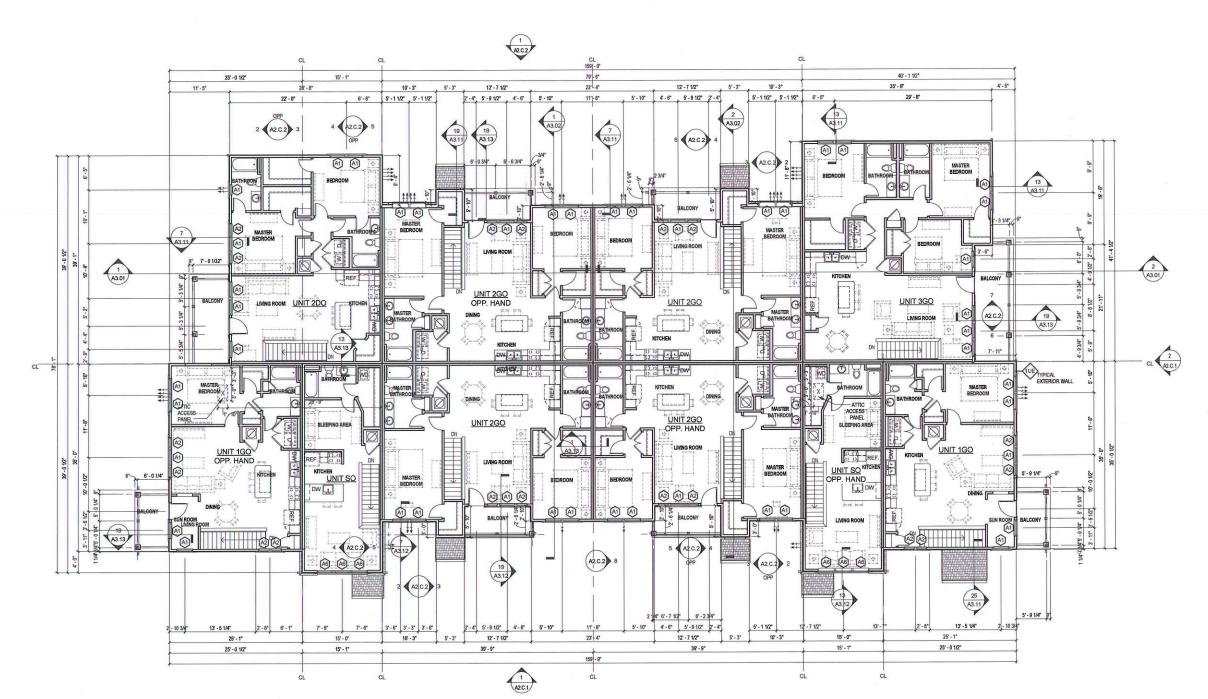

NOTE: NORTH ARROW ORIENTATION VARIES AT EACH BUILDING, SEE AS

Rochester, Mi

Drawing Date

MAY 13, 2015

BROADWAY

CONSTRUCTION DOCUMENTS

Project No.

215004.01

Sheet Title

SECOND FLOOR PLAN - BUILDING TYPE B16

SPRINGS AT SOUTH

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Sheet No. A1.C.12


BUILDING TYPE B16 KEYED NOTES LEGEND GENERAL NOTES UNIT TYPE MATRIX PROVIDE WOOD HANDRAIL AND BRACKETS AT INTERIOR STAIRS, WOOD SPECIES AND FINISH AS SELECTED BY OWNER. 1/8" BUILDING PLANS PROVIDED AS CONTROL DRAWING ONLY, REFER TO 1/4" UNIT LAYOUT PLANS FOR COMPLETE DIMENSIONS AND NOTES LOCATED ON A4 SHEETS. → MECHANICAL EXHAUST VENT ANSI TYPE A UNIT (1GCa) IN BUILDING 6 REFER TO SHEET A6.01 & A6.02 FOR WINDOW AND DOOR SCHEDULES. FLOOR ZND FLOOR TOTAL BLDG. BLDG. ##") BEARING WALL CENTERLINE TO CENTERLINE CONTRACTOR TO FIELD LOCATE END OF BUILDING TO RECEIVE METER BANK. LOCATE ON END OF BUILDING CLOSEST TO POWER COMPANY'S ELECTRICAL TRANSFORMER. ALL FIRST AND SECOND FLOOR PARTITIONS FOR THE APARTMENT BUILDINGS EXTEND FROM THE FLOOR TO UNDERSIDE OF THE FLOOR AND OR ROOF ASSEMBLY AT 9'-1 1/8' UNLESS OTHERWISE NOTED. CL CENERLINE OF TENANT SEPERATION WALLS ALL GROUND FLOOR PLANS SHALL BE CONSTRUCTED PER FAIR HOUSING REQUIREMENT & COMPLY WITH ACCESSIBILITY REQUIREMENTS. SEE UNIT PLANS & DEFINITIONS FOR COMPLIANCE FIRE SPRINKLER & ALARM DRAWINGS TO BE PROVIDED BY CONTRACTED FIRE SPRINKLER CONTRACTOR, PROVIDE SHOP DRAWINGS FOR REVIEW PRIOR TO THE SUBMITTAL TO THE COUNTY FOR ADDROVAL CONDENSER UNIT AND PADS ARE SHOWN AS GRAPHIC REPRESENTATION OF PAD LOCATION. COCRDINATE W MECHANICAL ENGINEERS DRAWINGS FOR ACTULA PAD LOCATION AND FREE AIR SPACE REQUIRED AROUND CONDENSERS. GARAGE 2GC -GARAGE 2GOa — GARAGE 2GOb — GARAGE 2GOb — GARAGE 2GOa — PROVIDE 1-HOUR RATED TENANT SEPARATION PARTITION AROUND ALL UNITS AND BLDG. COMMON CORRIDOR AND STAIRS PER UIL DESIGN SPECIFICATIONS. SEAL ALL PENETRATIONS IN WALLS TO MATCH RATINGS. REFER TO MEP DWGS, FOR FIRE ALARM, PULL, CONTROL PANEL, SIGNALS, BELL/HORN LOCATIONS AND EXIT SIGNS. GARAGE 2GC -GARAGE 3GC -

D15 11:13:11 AM

Sester-omnorod Banning Sester-omnorod Banning Banning



CONTINENTAL PROPERTIES
CONTINENTAL 338 FUND LLC
W134 N8675 EXECUTIVE PARKWAY
MENOMONEE FALLS, W1 53051
262.502.5500 * FAX 262.502.5522

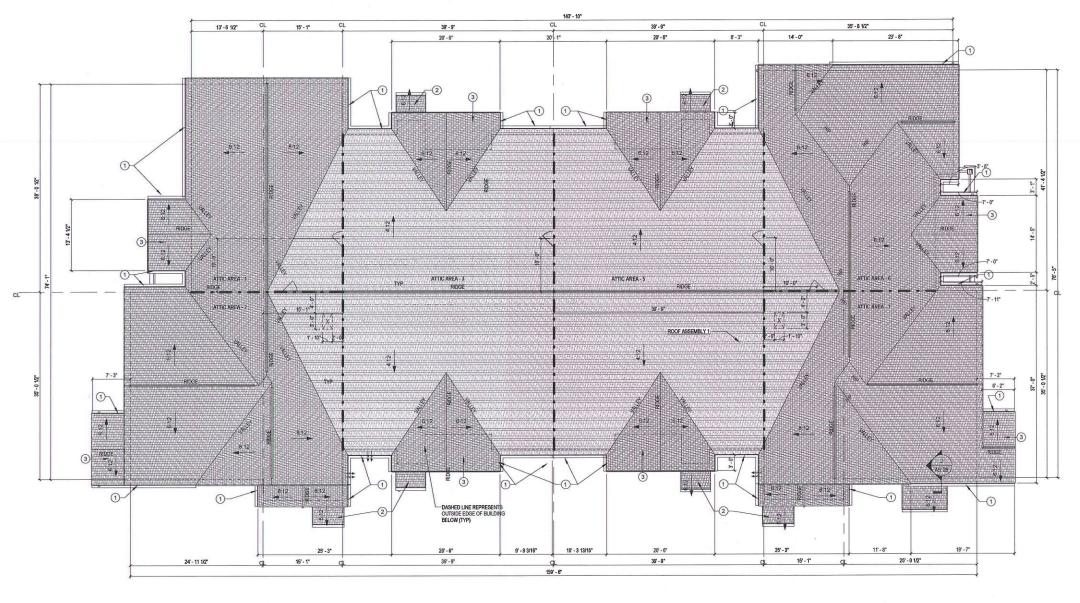

1/8" = 1'-0"

ENERAL NOTES	ROOF KEYNOTES	ROOF LE	GEND	ATTIC VE	NTILATION	ON SCHI	EDULE	=			MATERIALS AND COMPONENTS
ROOFING CONTRACTOR TO PROVIDE VENTILATION IN ACCORDANCE WY 2009 BIG. PROVIDE CALU. STEEL OR A LUMINUM RIDGE VENTS AND SOFFTY VENTS OR STEEL OR A LUMINUM RIDGE VENTS TO MATCH ROOF COLOR; SOFFIT VENTS TO MATCH SOFFIT COLOR. PROVIDE AIR BAFFLE VENT TRAYS IN EACH BAY OF ROOF TRUBSES TO WANTAIN AIRSPACE FOR VENTING. REFER TO WALL SECTIONS FOR SIZE AND TYPE OF VENTING AT EAVES. REFER TO ARCHITECTURAL, MECHANICAL, ELECTRICAL AND PLUMBINS PLANS FOR ROOF AND WALL PENETRATION LOCATIONS. REFER TO STRUCTURAL DRAWINGS FOR TRUSS LAYOUT AND CONFIGURATION. REFER TO DETAILS FOR TAPING REQUIREMENTS SEE AS 28. PROVIDE GUTTER SPLASH GUARDS AT ALL VALLEYS. PROVIDE AMIN, OR 38" O. G. G. MIL. SELF-ADHERED ROOFING MEMBRANE FLANKS AT ALL RAPE WALLS.	QUITER 1: OR FULL 1. QUITER 1: UNLESS OTHERWISE NOTED SEE BUILDING ASSEMBLIES AND COMPONENTS LEGEND ON WALL SECTIONS SHEETS FOR ADDITIONAL INFORMATION.	ROOF LE	DOWNSPOUT 22* x 96*LOCKABLE ATTIC ACCESS PANEL. REFER TO DETAIL 3/85.51 DRAFTSTOPPING IN ATTIC AREA. REFER TO FIRE BLOCKING AND DRAFTSTOPPING NOTES ON SHEET GO.20	AREA ATTIC AREA - 1 ATTIC AREA - 2 ATTIC AREA - 3 ATTIC AREA - 3 ATTIC AREA - 6 ATTIC AREA - 6 ATTIC AREA - 7 NOTE: **REQUIRED NET FI COLUMN SOM OF TI SOM OF TI SOM OF TI SOM OF TI **TE TI	ATTIC AREA (SQ FT) R 1292 1665 1650 12548 Not Placed 1559 1646 1559 1646 1559 1646 1650 AREA AND 100W, WHEN NO "HIC MIN, WHEN NO "HIC MIN, WHEN NO "HIC DID ROOK HIC MIN OF THE WENTER AND 100W INTER THE WENTER THE WENTER AND 100W INTER THE WENTER THE WENTE	TOTAL NET FRE VENTED AREA (1/300) (SG I 620 F20 F20 F20 F20 F20 F20 F20 F20 F20 F	E RIDGE (N) REQ* (L 310 396 611.5 611.5 611.5 083 395 BY MULTIPYIN 44 SQ INSQ F RIRED AT THE I RIPEYING THE A ULTIPYING THE A ULTIPYING THE A ULTIPYING THE A	50%) (SQ IN) ACT** INEAL FEET 17 22 34 34 21 22 GOTHE ACTUA THERECUIRED FROVIDED AT CITUAL LINEAL RID CITUAL RI) REQ* 310 396 611.5 611.5 383 395 L ATTIC ARE AND 50% IS NET FREE. THE SOFF	T (50%) (SQ IN) ACT*** (LINEAL FEET) 34 44 68 68 43 44 44 EA (SQ FT) IN REQUIRED THE AREA IS 1/150 OF IT. BY THE	MATERIALS AND COMPONENTS ROOF ASSEMBLY 1 20 YEARWO YEAR ARCHITECTURAL GRADE ASPHALT SHINGLES, 15# FELT PAPER, SEE PETER SHEEL DECADING, 12º OSB ROOF SHEATHING WITH METAL "H" CLIPS, PRE-ENGINEERED WOOD TRUSSES AT 24º O.C., R-49 BLOWN INSULATION, VAPOR RETARDER

CONSTRUCTION DOCUMENTS

Drawing Date MAY 13, 2015

Revisions

SPRINGS AT SOUTH BROADWAY

Rochester, MN

Project No.

215004.01

Sheet Title


ROOF PLAN -BUILDING TYPE B16

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A1.C.13



6) FIRST FLOOR PLAN - TYPE 6G GARAGE BUILDING 1/8" = 1'-0"

(16) WALL SECTION - EAVE AT OVERHEAD DOOR 1/2" = 1'-0"

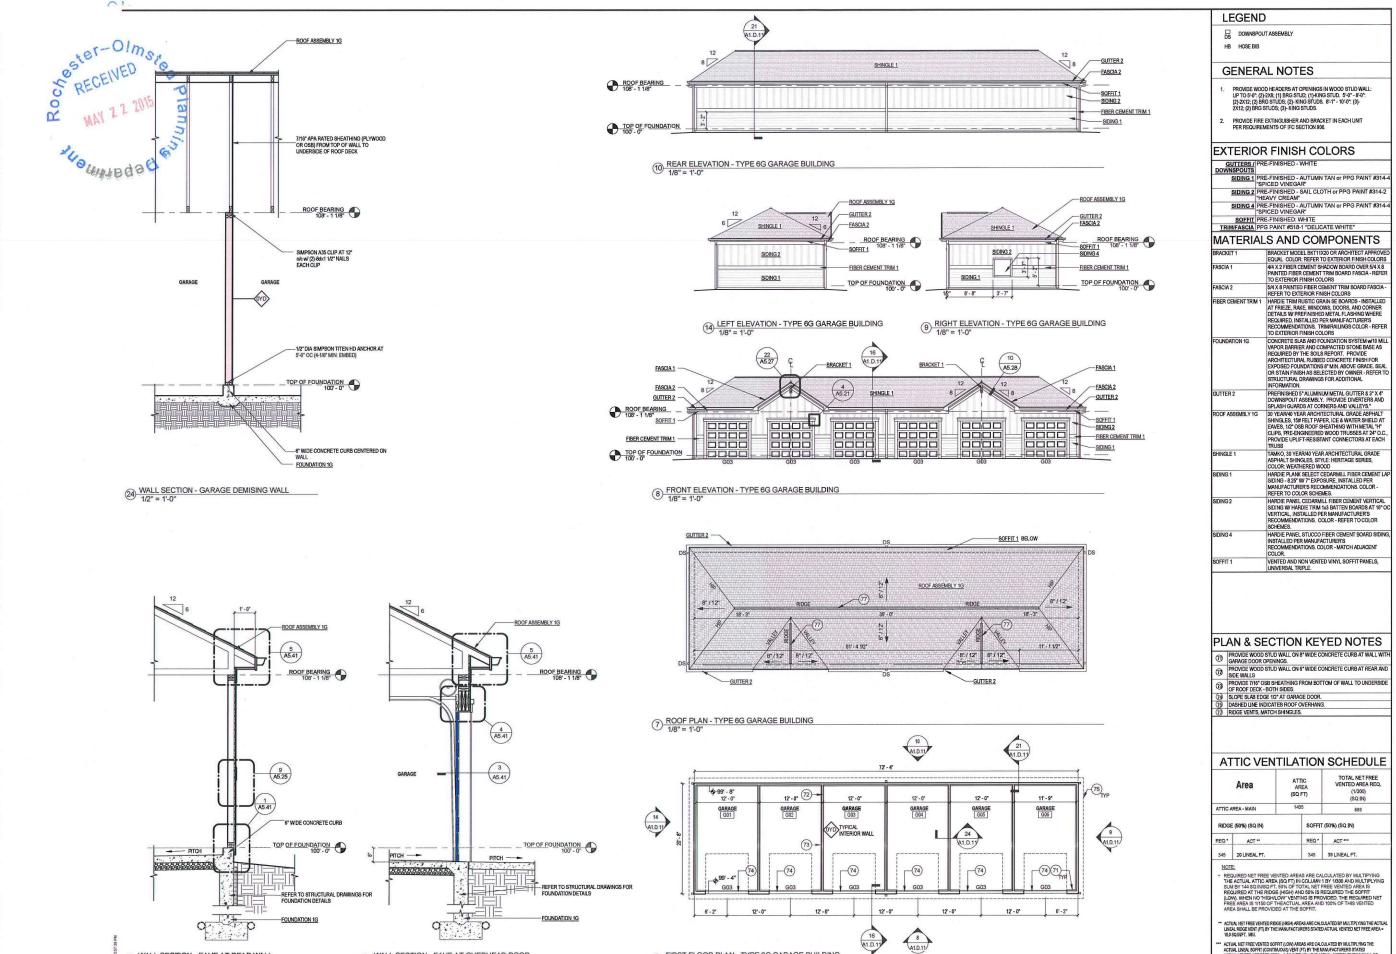②1 WALL SECTION - EAVE AT REAR WALL
1/2" = 1'-0"

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CONTINENTAL PROPERTIES

CONTINENTAL 326 FUND LLC W134 N8675 EXECUTIVE PARKWAY MENOMONEE FALLS, WI 53051 262.502.5500 * FAX 262.502.5522

MATERIALS AND COMPONENTS

HARDIE PANEL CEDARMILL FIBER CEMENT VERTICAL

	Area	ATTIC AREA (SQ FT)	TOTAL NET FR VENTED AREA F (1/300) (SQ IN)
ATTIC A	REA - MAIN	1435	689
RIDGE	E (50%) (SQ IN)	SOFFI	T (50%) (SQ IN)
REQ.	ACT **	REQ*	ACT ***
345	20 LINEAL FT.	345	39 LINEAL FT.

- ** ACTUAL INET FREE VENITED SOFFIT (LOW) AREAS ARE CALCULATED BY MULTIPLYING THE ACTUAL LINEAL SOFFIT (CONTINUOUS), VENT OFF, BY THE MANUFACTURERS STATED ACTUAL VENTE UNET FREE RAPE, SO SOUNT, MIN. THE ACTUAL SOFFIT VENTING SHALL EVENLY DISTRIBUTED BETWEEN EAVES.

CONSTRUCTION

DOCUMENTS

I hereby certify that this plan, specification, or

report was prepared by me or under my direct upervision and that I am a duly Licensed Architect

supervision and tina I am a culy Licensed Architect under the leve of the State of Minneadta

Print Name: The RASCHE

Signature: The RASCHE

Signature: The RASCHE

License # 42070

Drawing Date MARCH 13, 2015

SPRINGS AT SOUTH **BROADWAY**

310 - 680 28TH STREET SE ROCHESTER, MN 55904

Project No.


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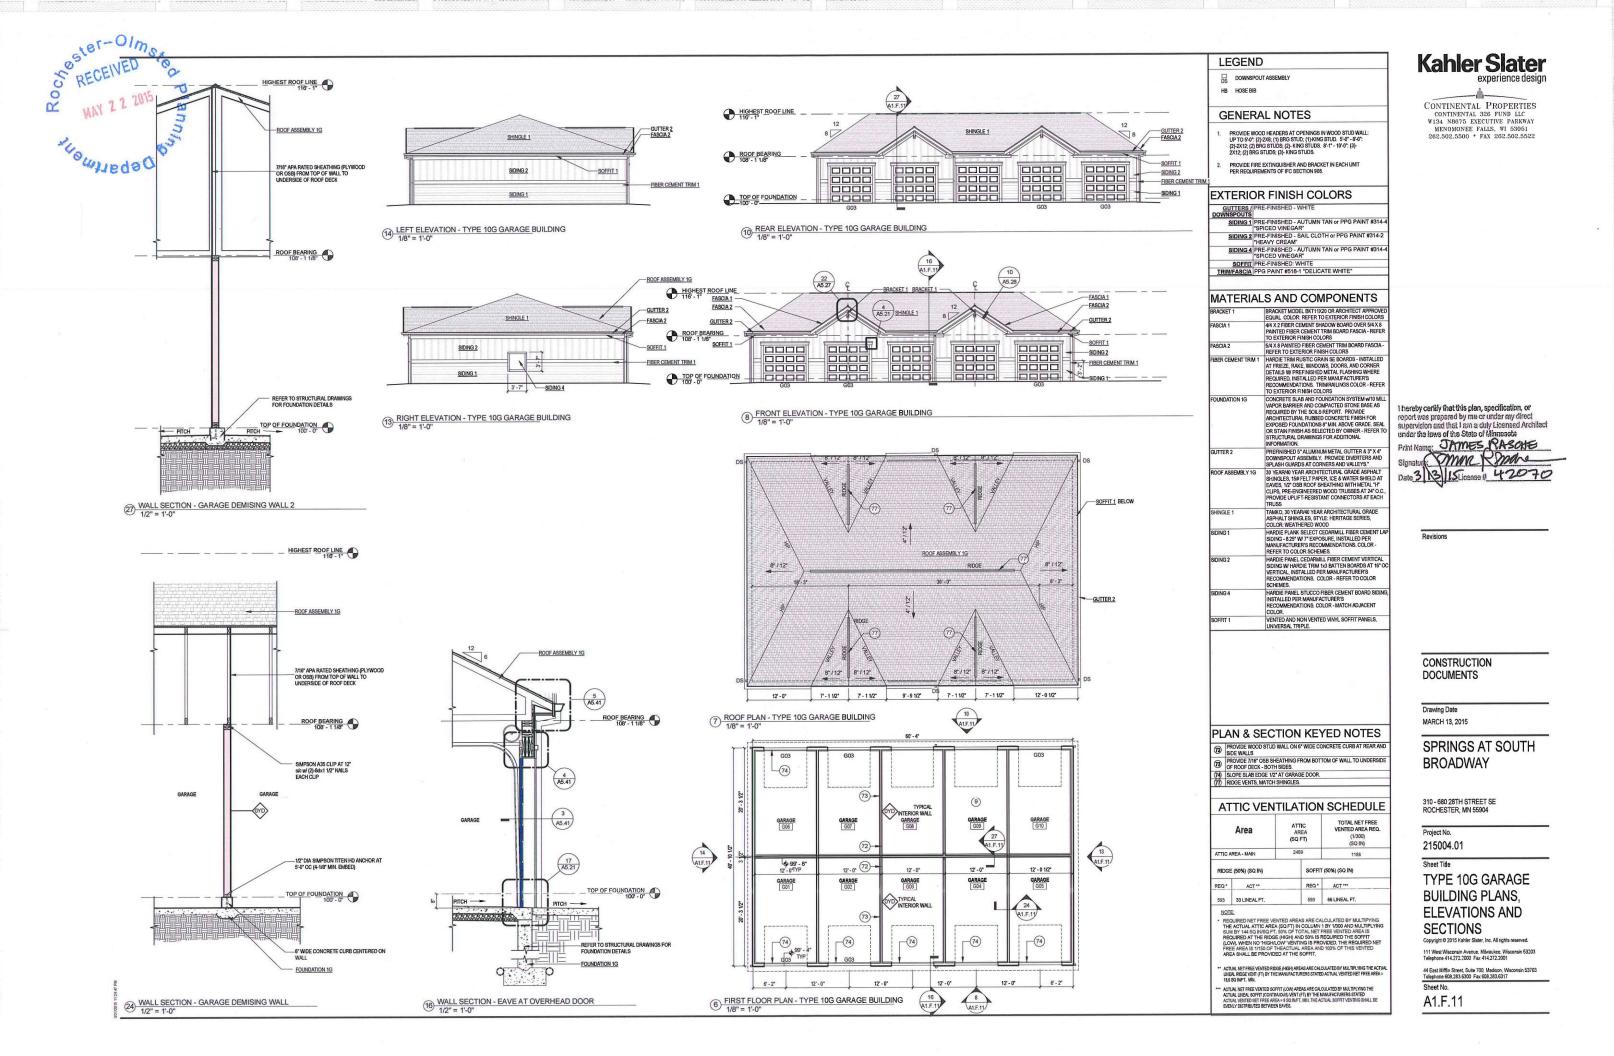
TYPE 6G GARAGE BUILDING PLANS. **ELEVATIONS AND**


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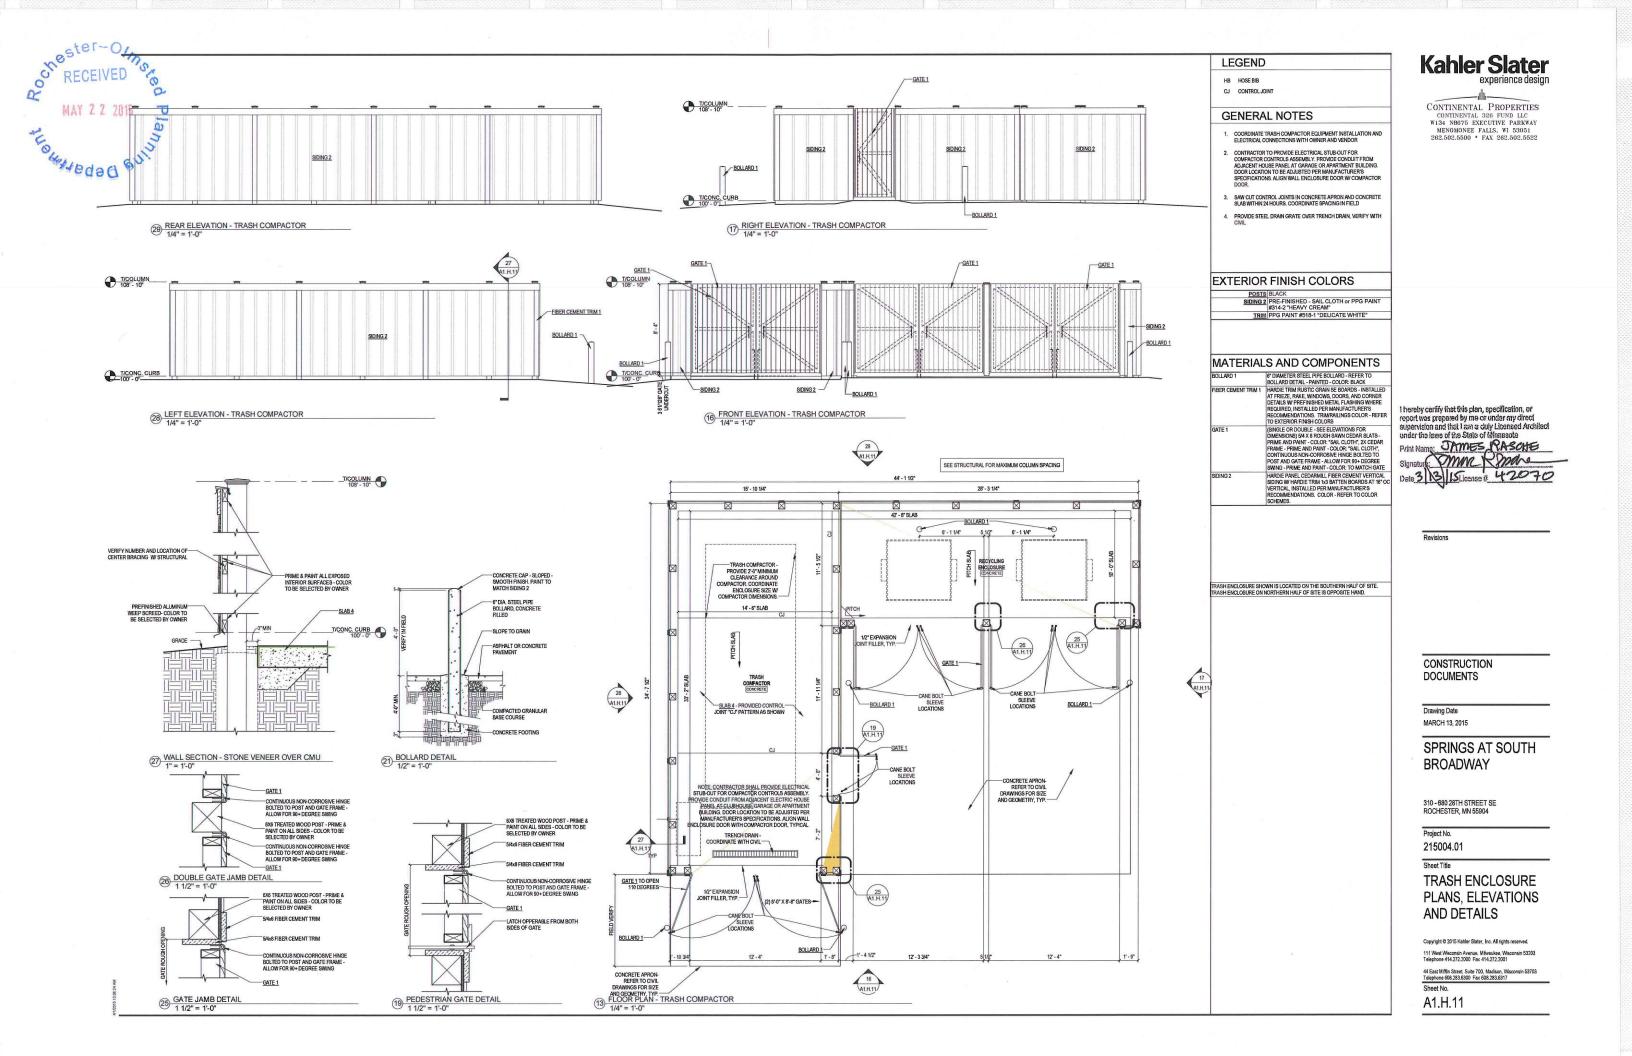
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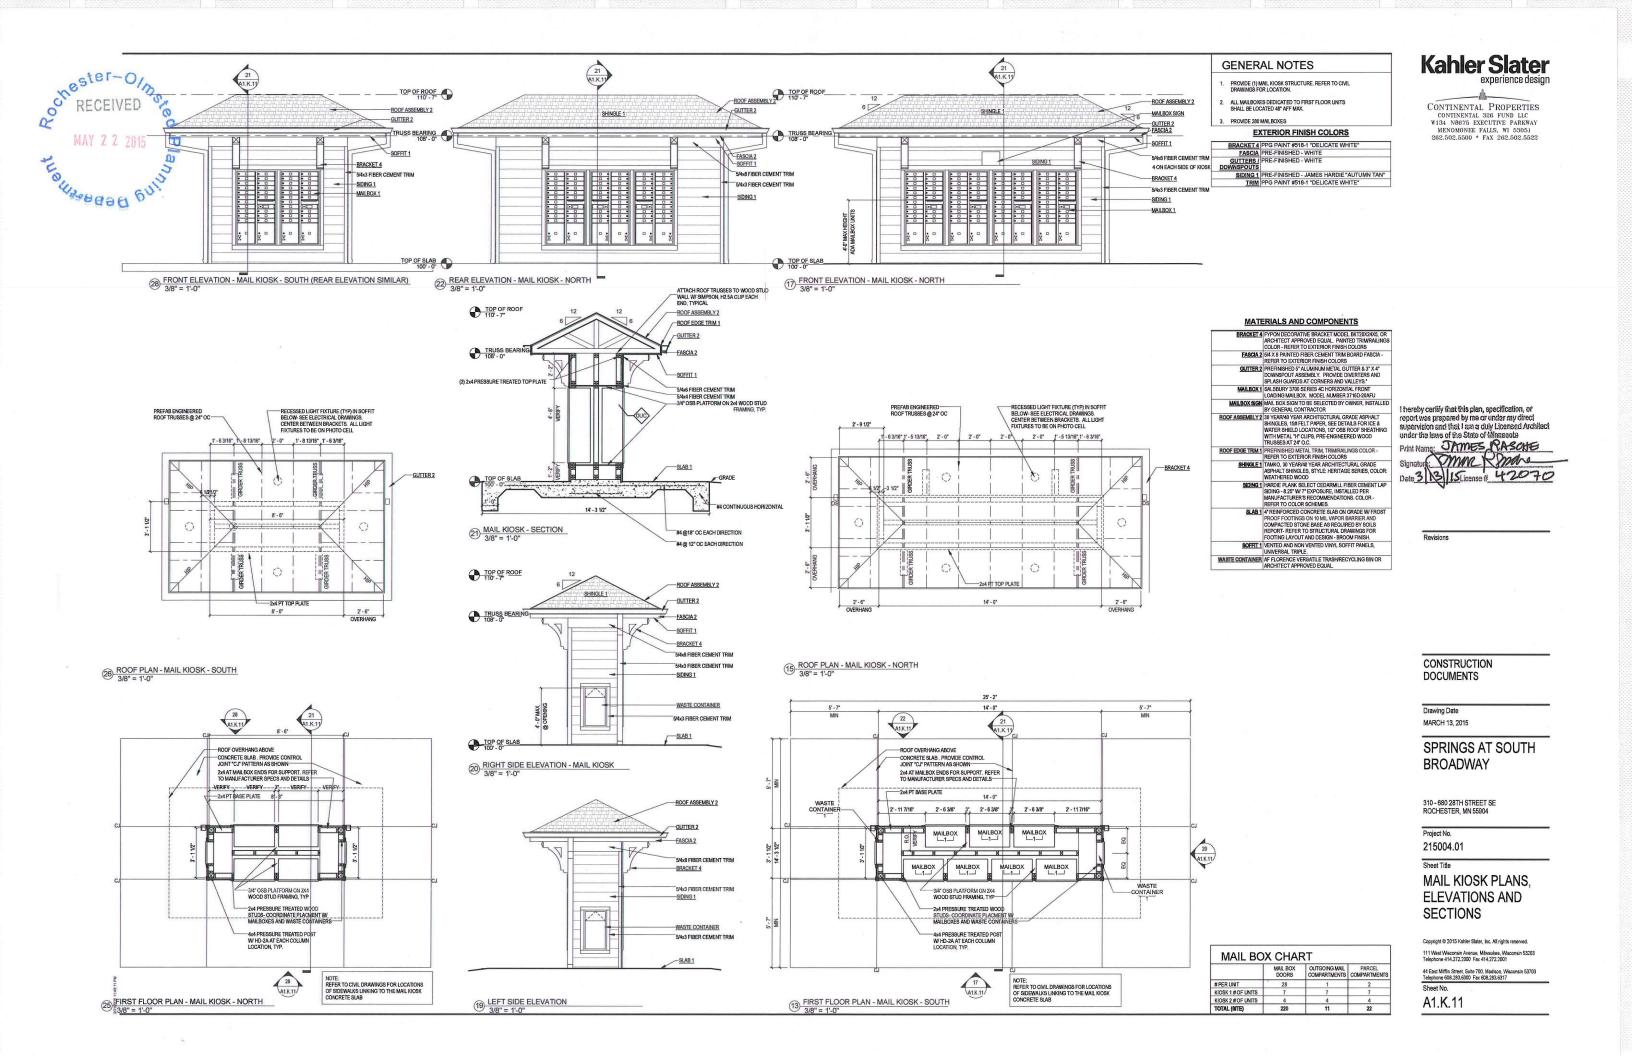
A1.D.11








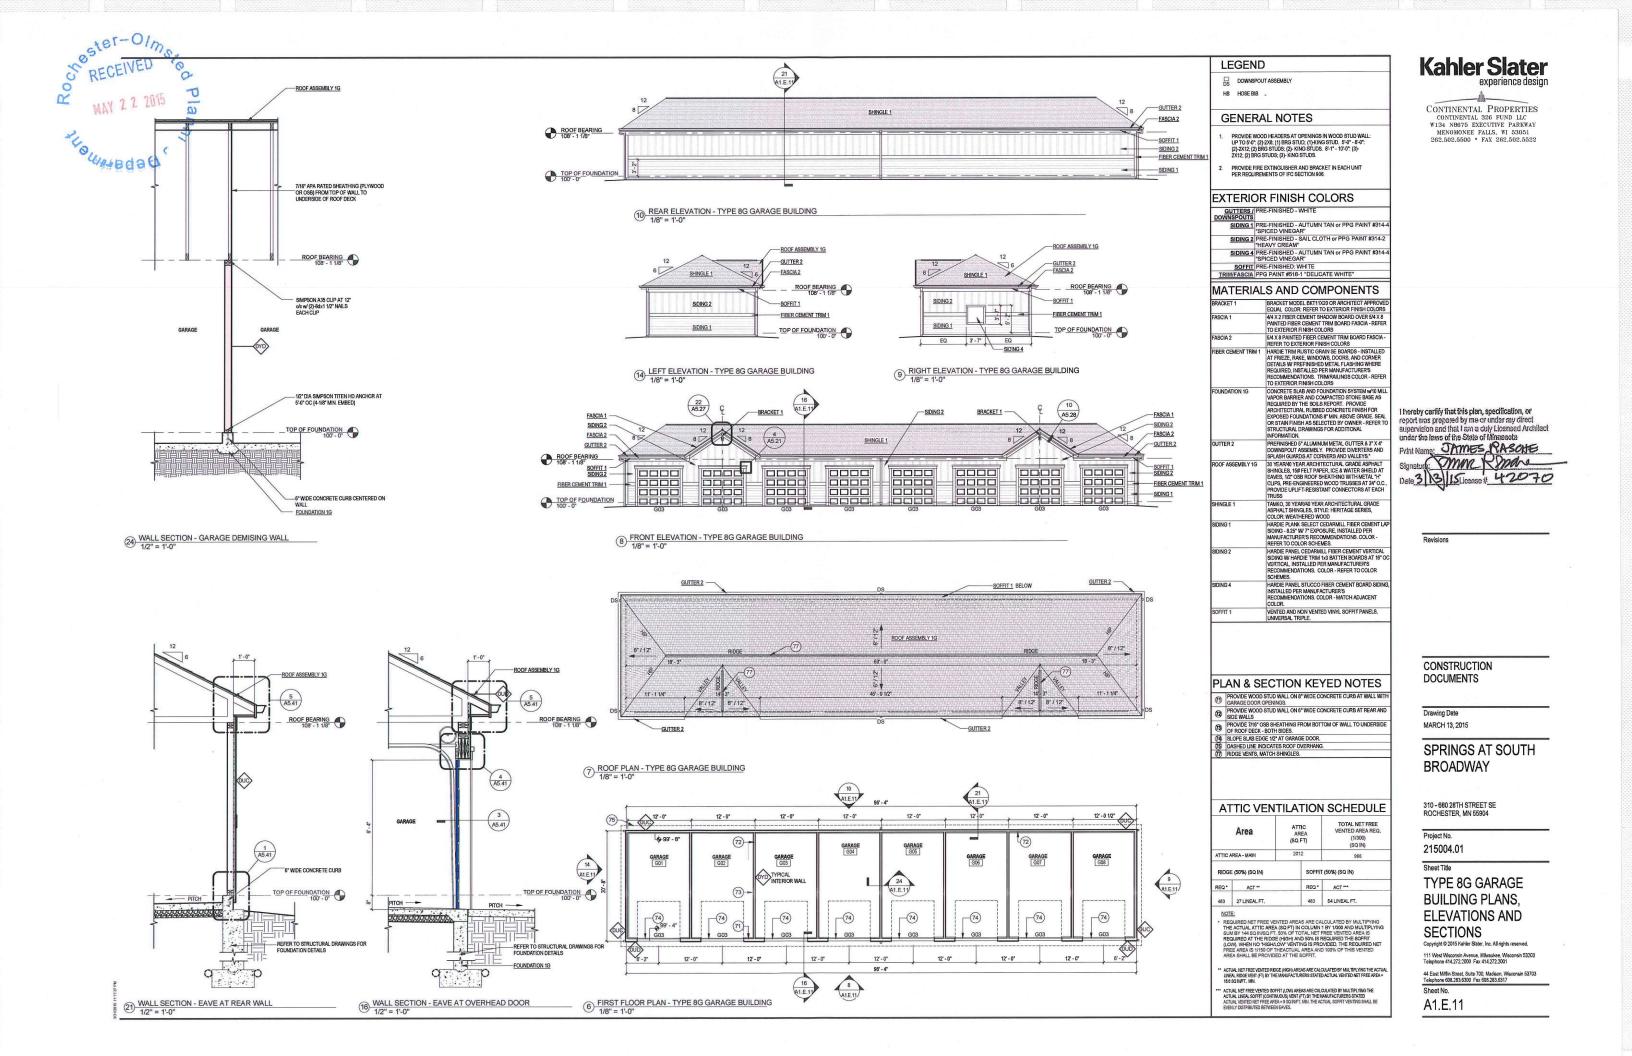


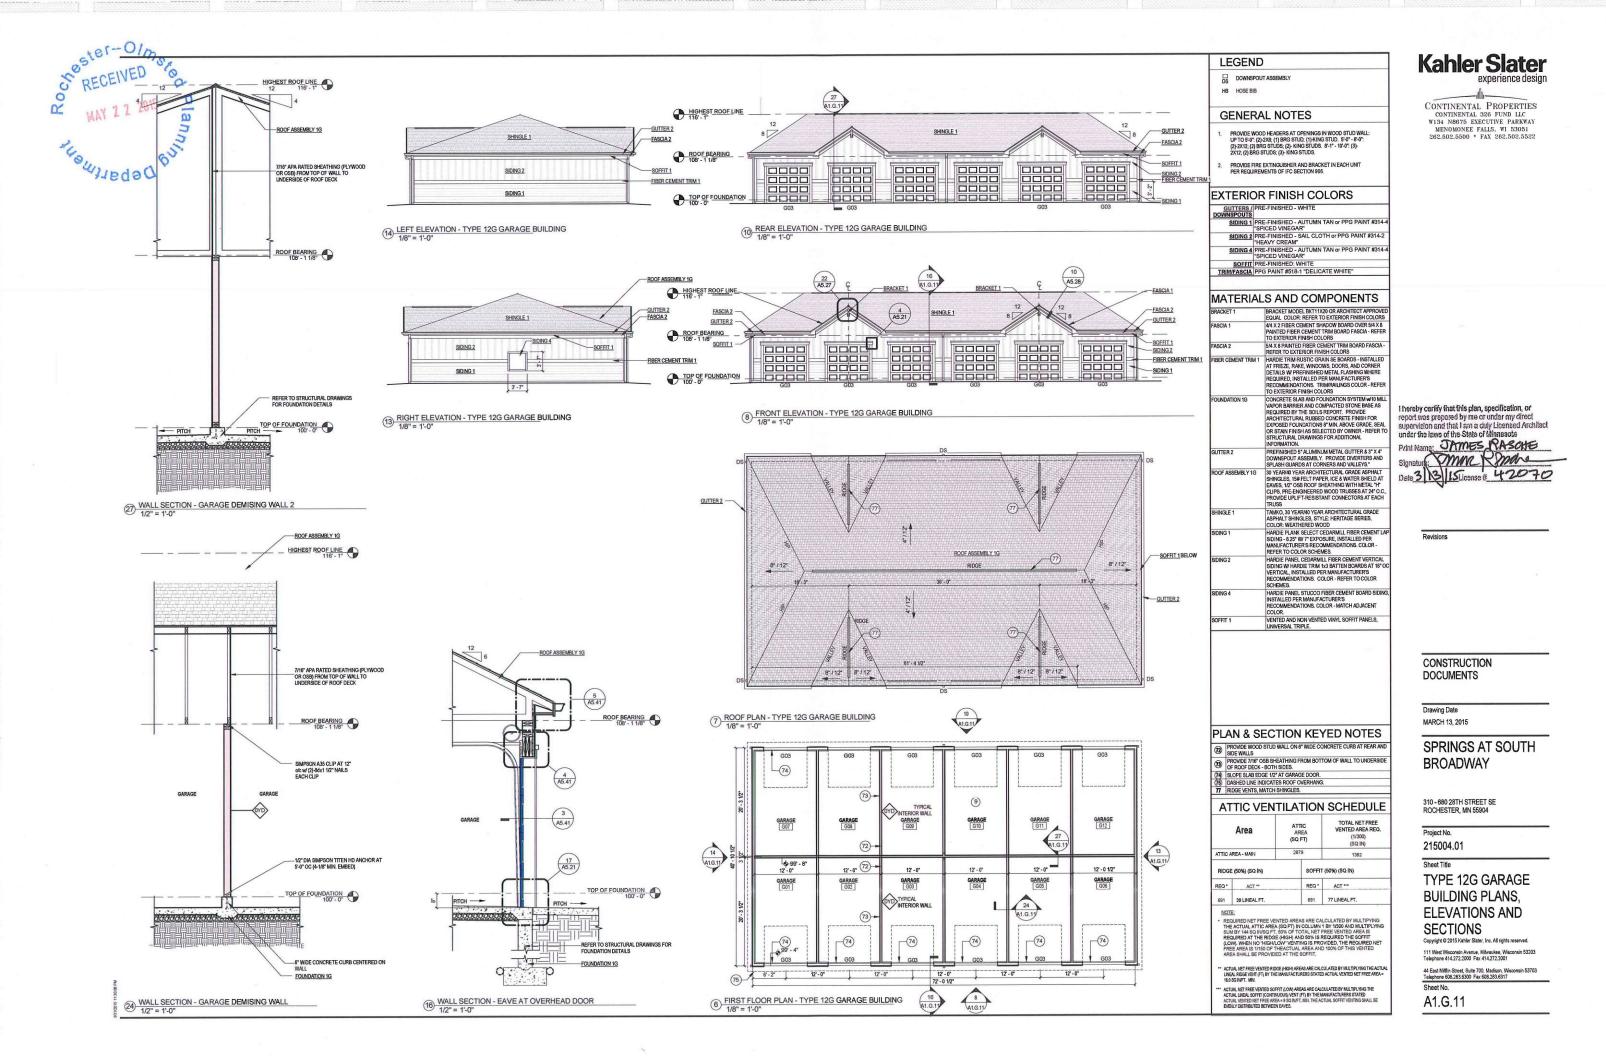


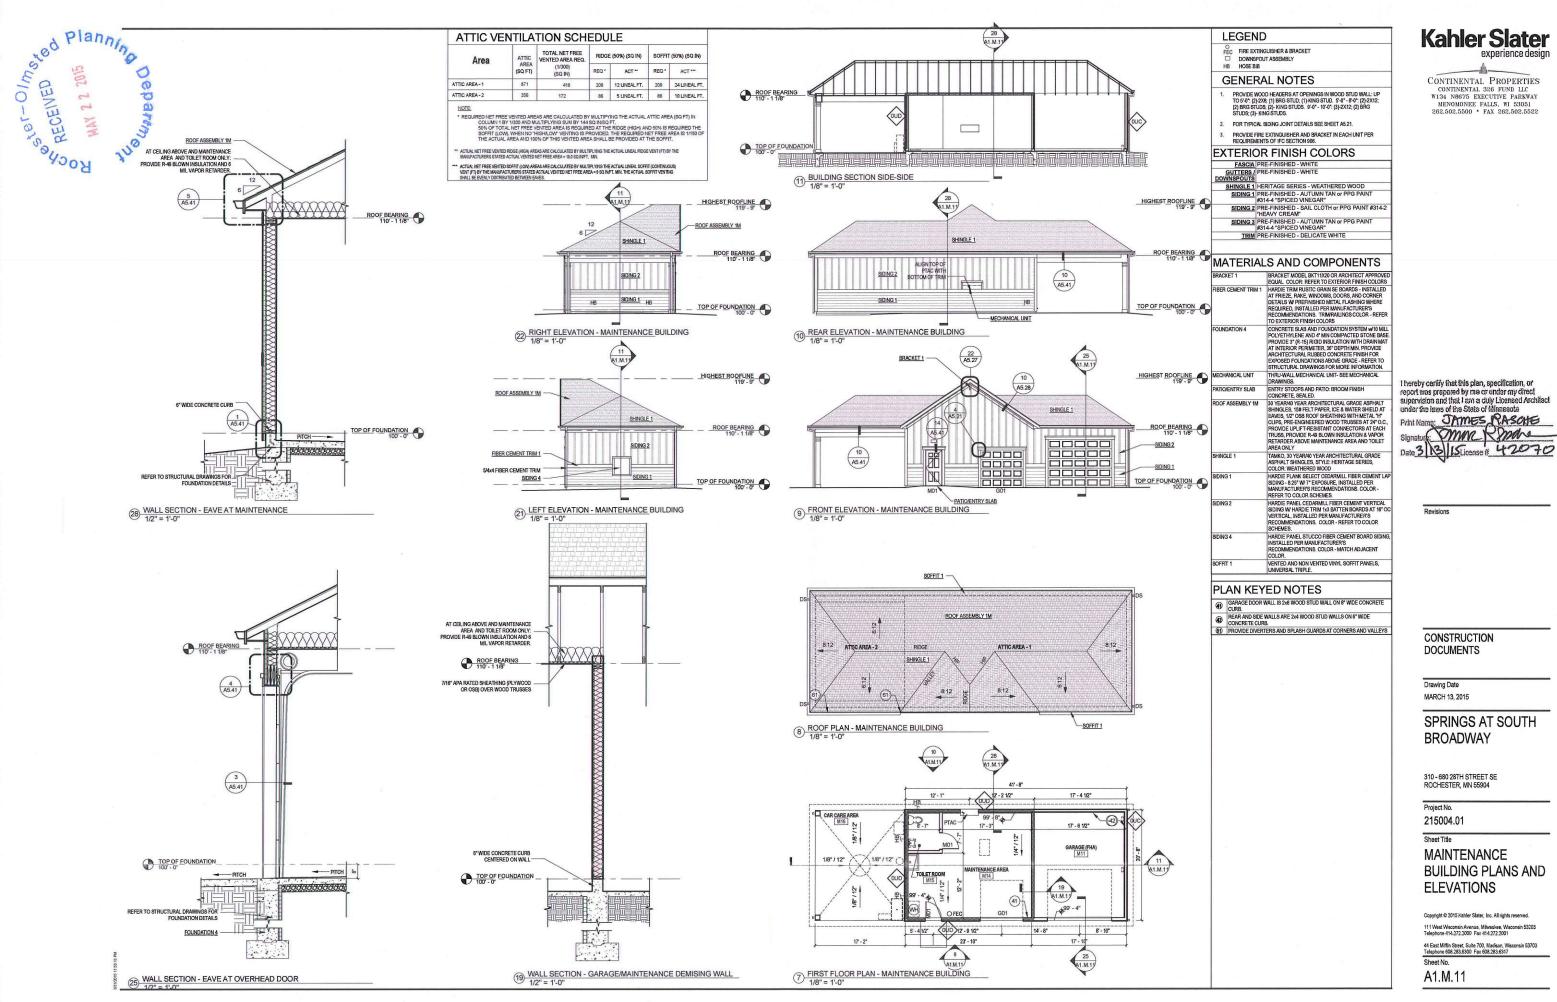

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BUILDING PLANS AND



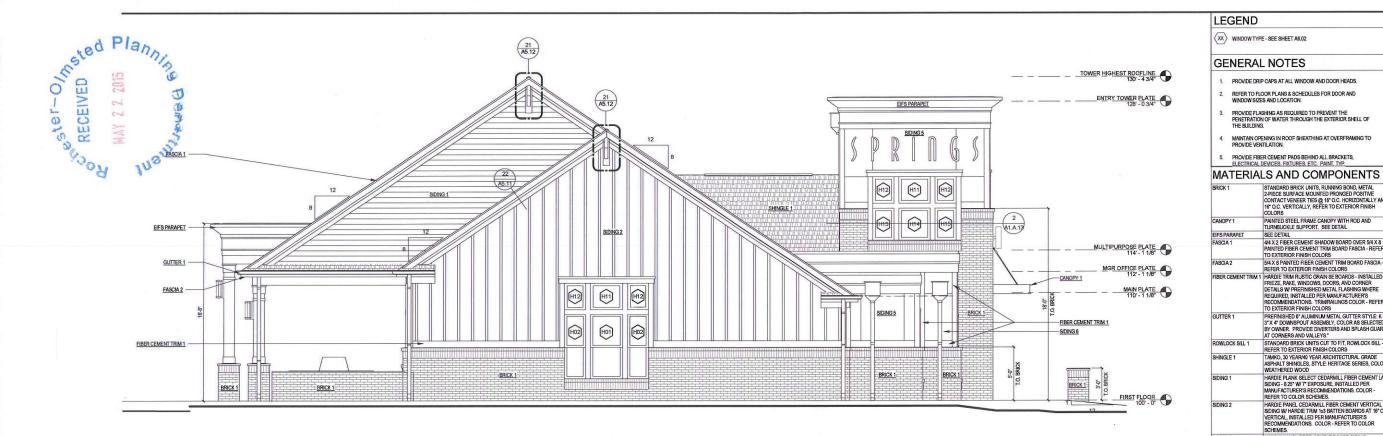
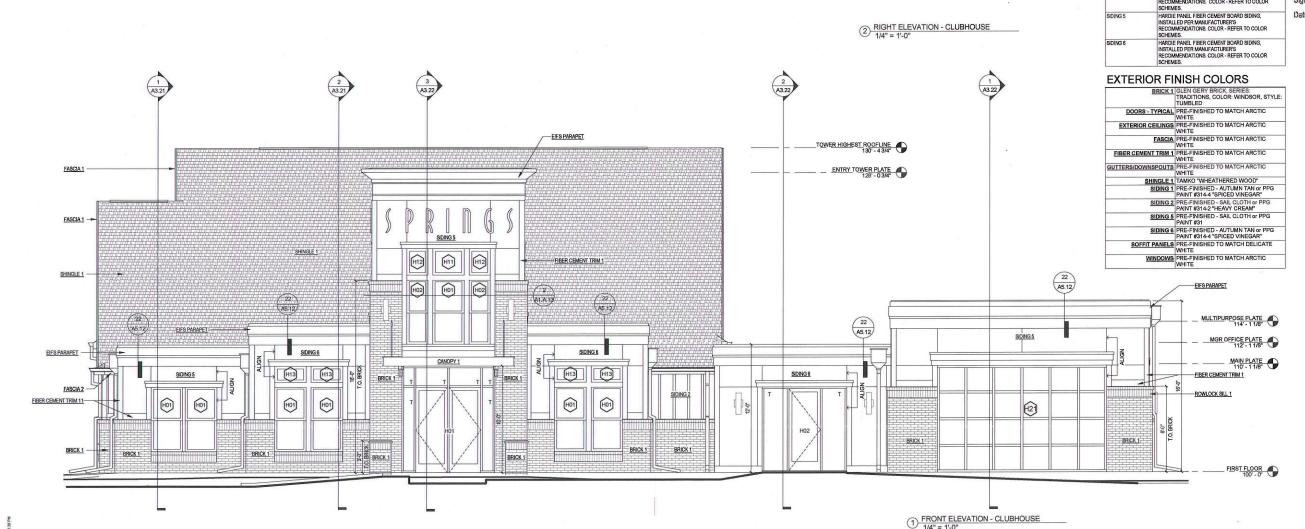
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I trereby certify that this plan, specification, or report was prepared by me or under my direct supervision and that I am a duly Licensed Architect under the laws of the State of Mignesota

Print Name: TAMES RASCHE
Signatura: TMM SMM
Date 3 13 15 License it 42070

Revisions

ALS AND COMPONENTS

STANDARD BROCK UNITS, RUANING BOND, METAL
2-HECE SURFACE MOUNTED PROVIDED PROTITIVE
COLORS

OF A CHARLES TIES & TO C. HORIZONTALLY, MAD
COLORS

TO CHARLES TIES & TO C. HORIZONTALLY, MAD
COLORS

TO CHARLES TIES & TO C. HORIZONTALLY, MAD
COLORS

HAVE PERFECT BETALLES CANDED WITH HOD AND
TURRIBLOKE SURPORT. SEE DETAIL

44 X.F. PIER CEMENT SHOOW BOARD OKER SIX X.

44 X.F. PIER CEMENT SHOOW BOARD OKER SIX X.

44 X.F. PIER CEMENT SHOOW BOARD OKER SIX X.

45 YEAR CEMENT SHOOW BOARD OKER SIX X.

46 X.F. PIER CEMENT SHOOW BOARD OKER SIX X.

47 HARDIE FERRE CEMENT TIME BOARD FASCIA - REFER
POBLITIES FERRE CEMENT TIME BOARD FASCIA REFER OF DETERIOR FRISH TO LORS

AT HARDIE FAME VINITIO GOR IN SER ROAD CONBER
SETALL SW PREFINISHED METAL FLASHING WHERE
REQUIRED INSTALLED PER MANUFACTURER'S

RECOMMENDATIONS TRAINFAUNTS COLORS - REFER
TO EXTERIOR FINISH COLORS

PREFINISHED OF ALLIMITUM METAL GUTTER STYLE X.

3"X X POWNISPOUT ASSEMBLY, COLOR AS SELECTED

BY OWNER, PROVIDE DIVERTIES AND SPLASH GUARDS

AT CORNERS AND VALLEYS*

STANDARD BRICK UNITS GUT TO FIT, ROWLOCK SILL
REFER TO EXTERIOR FINISH COLORS

ASPHALT SHINGLE MISTS GUT TO FIT, ROWLOCK SILL
REFER TO EXTERIOR FINISH COLORS

ASPHALT SHINGLES STYLE HERITAGE SERIES, COLOR

WASHINGTON SELECTED

MANUFACTURER'S RECOMMENDATIONS. COLOR
WASHINGTON SELECTED

MANUFACTURER'S RECOMMENDATIONS. COLOR
MANUFACTURER'S RECOMMENDATIONS. COLOR
MANUFACTURER'S RECOMMENDATIONS. COLOR
MANUFACTURER'S RECOMMENDATIONS. COLOR
METER TO COLOR SOHEMS.

HARDIE PANEL FIBER CEMENT BOARD SIDING,

SICHMESS.

CONSTRUCTION DOCUMENTS

Drawing Date MARCH 13, 2015

SPRINGS AT SOUTH **BROADWAY**

560 28TH STREET SE ROCHESTER, MN 55904

Project No.


215004.01 Sheet Title

EXTERIOR ELEVATIONS -CLUBHOUSE

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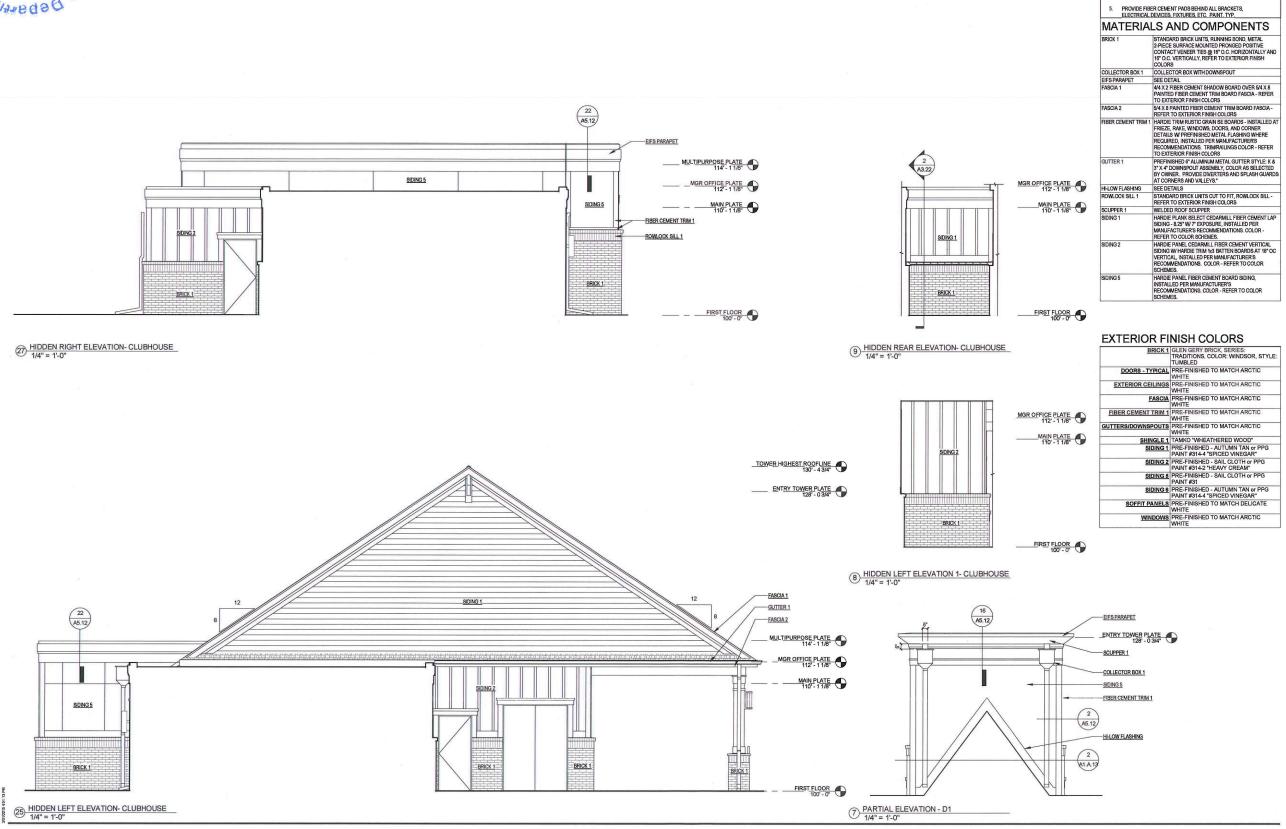
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A2.A.1



A2.A.2

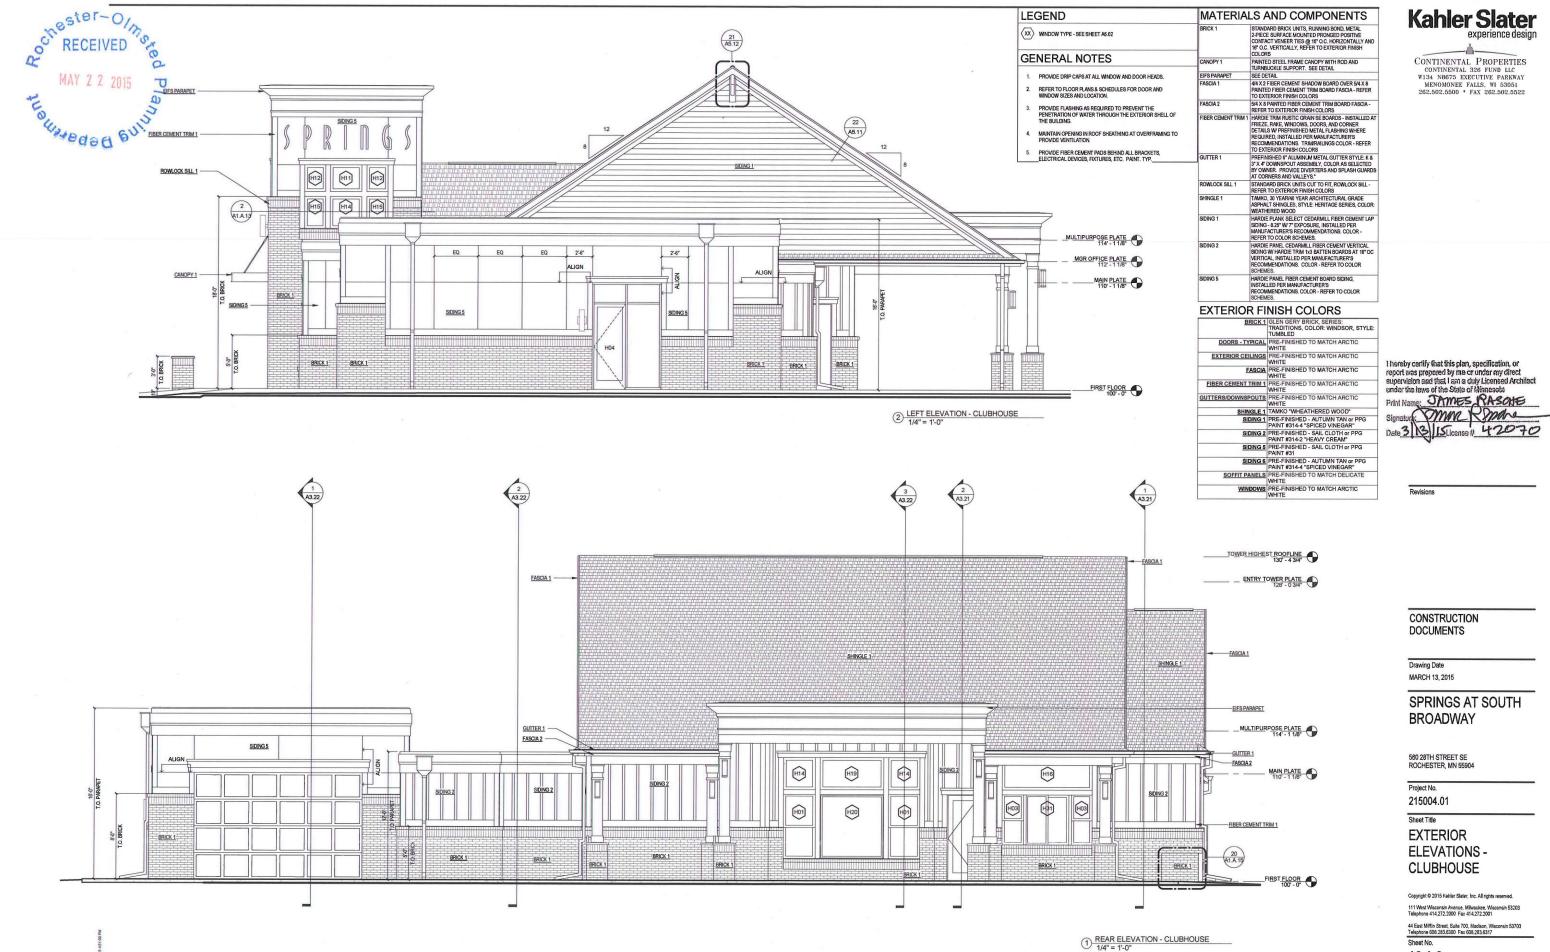



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LEGEND

windowtype-see sheet A6.02

GENERAL NOTES

PROVIDE DRIP CAPS AT ALL WINDOW AND DOOR HEADS.

REFER TO FLOOR PLANS & SCHEDULES FOR DOOR AND
WINDOW SIZES AND LOCATION.

PROVIDE FLASHING AS REQUIRED TO PREVENT THE
PENETRATION OF WATER THROUGH THE EXTERIOR SHELL OF
THE BULLOINS.

CONTINENTAL PROPERTIES CONTINENTAL 326 FUND LLC W134 N8675 EXECUTIVE PARKWAY MENOMONEE FALLS, WI 53051 262.502.5500 * FAX 262.502.5522

Thereby certify that this plan, specification, or report was prepared by me or under my direct supervision and that I am a duly Licensed Architect under the laws of the State of Minnesota

Print Name: Sames Rasche

Signature: Many Rasche

Signatu

Date 3 13 15 License # 42070

Revisions

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Drawing Date MARCH 13, 2015

SPRINGS AT SOUTH BROADWAY

560 28TH STREET SE ROCHESTER, MN 55904

Project No.

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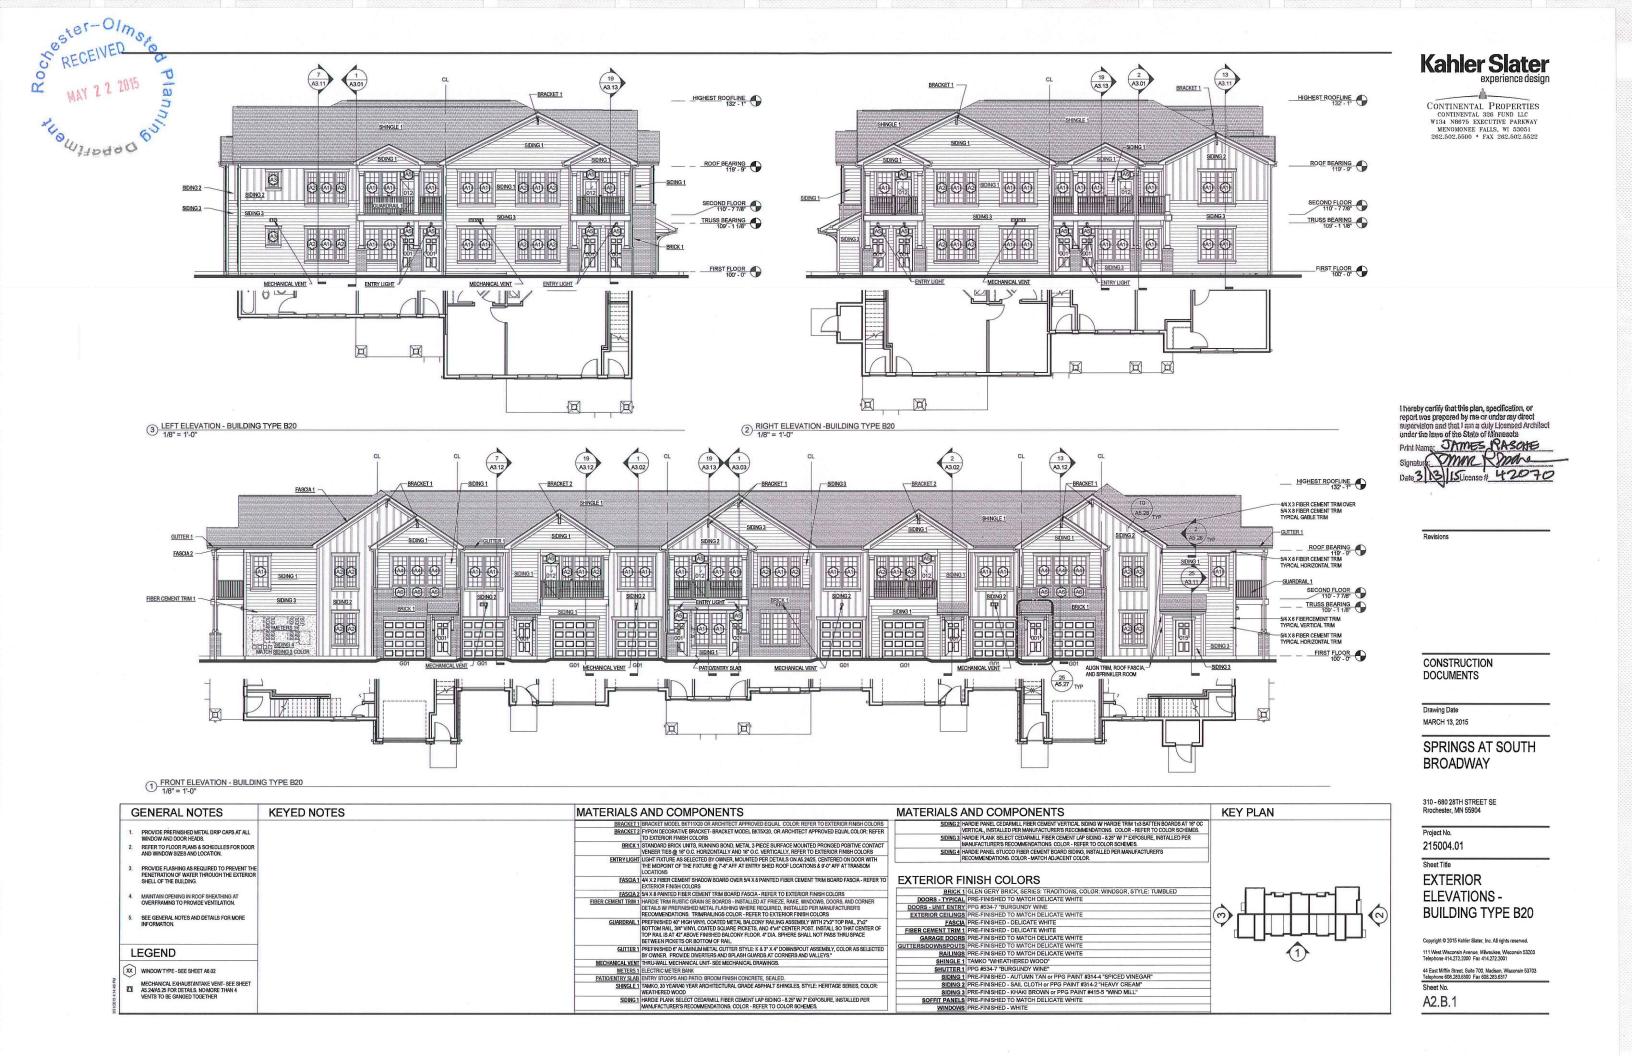
EXTERIOR PARTIAL ELEVATIONS - CLUBHOUSE

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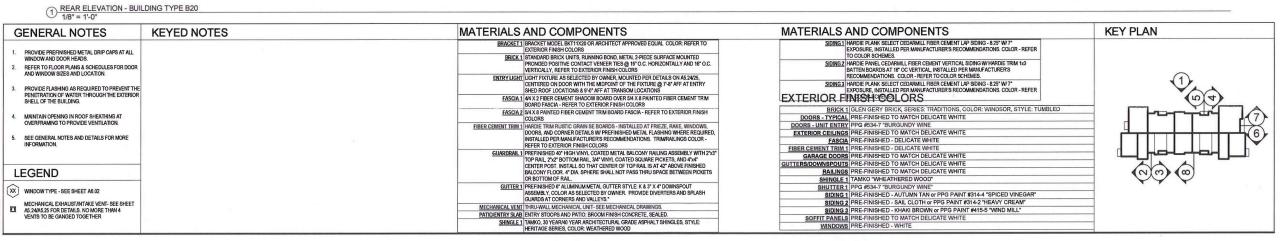
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Sheet No. A2,A,3



RECEIVED OF Planning MAY 2 2 2015 Separtino A. SHINGLE 1 -SHINGLE 1 FASCIA 1 SHINGLE 1 SHINGLE 1 -SHINGLE 1 ROOF BEARING 119' - 9" ROOF BEARING ROOF BEARING 119' - 9" ROOF BEARING ROOF BEARING ROOF BEARING SIDING 1 -SIDING 2 SIDING 1--SIDING 1 **GUARDRAIL 1** -GUARDRAIL SECOND FLOOR SECOND FLOOR SECOND FLOOR SECOND FLOOR BRICK 1 -MECHANICAL VENT SIDING 3 (SEE MECHANICAL UNIT PLANS FOR NUMBER OF VENTS AT EACH UNIT FOR PARTIAL ELEVATION D1) -SIDING 1 PATIO/ENTRY SLAE FIRST FLOOR FIRST FLOOR FIRST FLOOR FIRST FLOOR FIRST FLOOR 8 PARTIAL ELEVATION - D1 3 PARTIAL ELEVATION - A2 4 PARTIAL ELEVATION - B1 5 PARTIAL ELEVATION - B2 6 PARTIAL ELEVATION - C1 7 PARTIAL ELEVATION - C2





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Thereby certify that this plan, specification, or report was prepared by me or under my direct supervision and that I am a duly Licensed Architect under the laws of the State of Minneauta

Date 3 13 15 License # 42070

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EXTERIOR ELEVATIONS -

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BUILDING TYPE B20

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